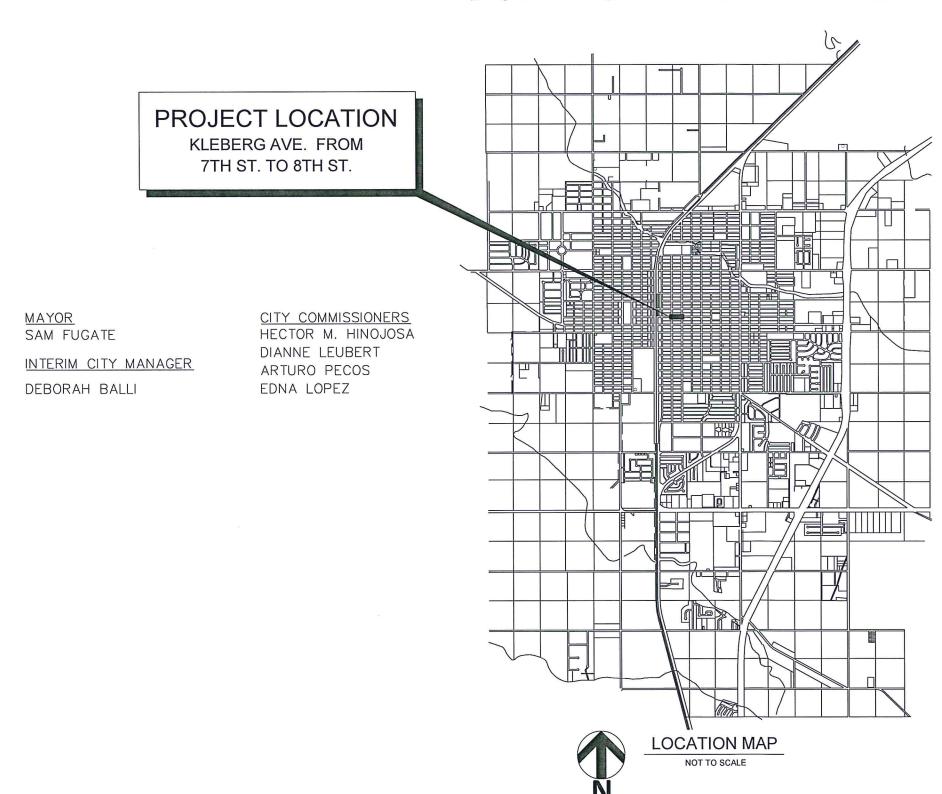
CITY OF KINGSVILLE

2018-2019 **DOWNTOWN IMPROVEMENTS**

NOVEMBER 2019



SHEET INDEX

SHEET	TITLE
1	COVER SHEET
2	GENERAL NOTES & OVERALL SITE PLAN
3	STA1+00 TO STA. 1+50 (EXISTING PLAN)
4	STA. 1+50 TO STA. 3+50 (EXISTING PLAN)
5	STA. 3+50 TO STA. END (EXISTING PLAN)
6	STA1+00 TO STA. 1+50 (DEMOLITION PLAN)
7	STA. 1+50 TO STA. 3+50 (DEMOLITION PLAN)
8	STA. 3+50 TO STA. END (DEMOLITION PLAN)
9	STA1+00 TO STA. 1+50 (PROPOSED PLAN)
10	STA. 1+50 TO STA. 3+50 (PROPOSED PLAN)
11	STA. 3+50 TO STA. END (PROPOSED PLAN)
12	PROPOSED KLEBERG AVENUE & 7TH ST. BULB OUTS
13	PROPOSED KLEBERG AVENUE & 8TH ST. BULB OUTS
14	ELECTRICAL SITE PLAN
15	DECORATIVE LAMP DETAILS
16	MISCELLANEOUS DETAILS I
17	MISCELLANEOUS DETAILS II
18	MISCELLANEOUS DETAILS III
19	MISCELLANEOUS DETAILS IV
20	TRAFFIC CONTROL PLAN - TCP (2-2) - 18

THE SEAL APPEARING ON THIS DOCUMENT WAS AUTHORIZED BY RUTILIO P. MORA JR, P.E. NO. 111588 ON 11-04-19. ALTERATION OF A SEALED DOCUMENT WITHOUT PROPER NOTIFICATION TO THE RESPONSIBLE ENGINEER IS AN OFFENSE UNDER THE TEXAS ENGINEERING PRACTICE ACT.



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DOWNTOWN IMPROVEMENTS COVER SHEET 2018-2019

GENERAL CONSTRUCTION NOTES:

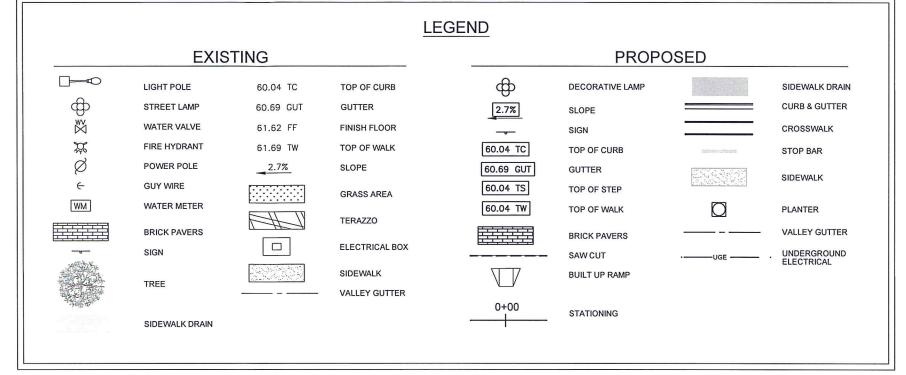
- 1. ALL IMPROVEMENTS TO BE IN ACCORDANCE WITH CITY OF KINGSVILLE CODES.
- CONTRACTOR TO VERIFY LOCATION AND ELEVATION OF EXISTING FACILITIES PRIOR TO CONSTRUCTION.
- CONTRACTOR TO PLAN AND PERFORM HIS WORK IN A MANNER THAT WILL PERMIT SAFE PUBLIC TRAFFIC MOVEMENT ON ALL STREETS.
- 4. TEMPORARY TRAFFIC CONTROL DURING CONSTRUCTION TO BE IN ACCORDANCE WITH SPECIFICATIONS.
- 5. CONTRACTOR SHALL PROVIDE PROTECTIVE DEVICES SUCH AS SIGNS, LIGHTS, AND SIGNALS FOR THE SAFETY OF THE PUBLIC AND WORKERS, AS REQUIRED, AND AS DIRECTED BY CITY INSPECTOR.
- CONTRACTOR TO BE RESPONSIBLE FOR PROTECTION AND/OR SAFETY OF THE WORK SITE, WORKERS, SUBCONTRACTORS, MATERIALS AND/OR EQUIPMENT.
- 7. CONSTRUCTION STAKING SHALL BE PROVIDED BY THE CONTRACTOR AND AT CONTRACTOR'S EXPENSE. BASE LINES ARE STAKED AS SHOWN ON PLANS. ALL DIMENSIONS ARE TO BACK OF CURBS UNLESS SHOWN OTHERWISE.
- 8. MATERIAL TESTING SHALL BE PROVIDED BY THE CITY OF KINGSVILLE. RE-TEST DUE TO FAILURES TO BE AT CONTRACTOR'S EXPENSE.
- 9. CONTRACTOR SHALL SUBMIT A TRAFFIC CONTROL PLAN FOR APPROVAL BY THE CITY ENGINEERING OFFICE PRIOR TO CONSTRUCTION. CONTRACTOR MAY CLOSE STREETS TO THRU TRAFFIC IN INCREMENTS AS LONG AS ACCESS IS MAINTAINED TO ALL RESIDENCES, BUSINESSES, & ADJOINING STREETS. TRAFFIC CONTROL PLAN WILL BE IN ACCORDANCE WITH TXDOT'S TCP (2-2) 18 ON SHEET 16 AND THE TEXAS MANUAL ON UNIFORM TRAFFIC CONTROL DEVICES.
- CONTRACTOR SHALL BE RESPONSIBLE FOR OBTAINING ALL PERMITS REQUIRED AND AT CONTRACTOR'S EXPENSE.
- 11. ANY DAMAGE TO EXISTING PAVEMENT, DRAINAGE OR EXISTING STRUCTURES SHALL BE REPAIRED TO PRE-CONSTRUCTION CONDITION AT CONTRACTOR'S EXPENSE.
- 12. "THESE PLANS, PREPARED BY THE CITY OF KINGSVILLE ENGINEERING DEPARTMENT DO NOT EXTEND TO OR INCLUDE DESIGNS OR SYSTEMS PERTAINING TO THE SAFETY OF THE CONSTRUCTION CONTRACTOR OR ITS EMPLOYEES, AGENTS OR REPRESENTATIVES IN THE PERFORMANCE OF THE WORK. THE SEAL OF CITY OF KINGSVILLE'S REGISTERED PROFESSIONAL ENGINEER(S) HEREON DOES NOT EXTEND TO ANY SUCH SAFETY SYSTEMS THAT MAY NOW OR HEREAFTER BE INCORPORATED IN THESE PLANS. THE CONSTRUCTION CONTRACTOR SHALL PREPARE OR OBTAIN THE APPROPRIATE SAFETY SYSTEMS, INCLUDING THE PLANS AND SPECIFICATIONS REQUIRED BY THE HOUSE BILLS 662 AND 665 ENACTED BY THE TEXAS LEGISLATURE IN THE 70TH LEGISLATURE REGULAR SESSION."
 13. CONTRACTOR SHALL GIVE NOTICE TO ALL AUTHORIZED INSPECTORS, SUPERINTENDENTS, OR
- 13. CONTRACTOR SHALL GIVE NOTICE TO ALL AUTHORIZED INSPECTORS, SUPERINTENDENTS, OR PERSONS IN CHARGE OF PRIVATE AND PUBLIC UTILITIES AFFECTED BY HIS OPERATIONS PRIOR TO COMMENCEMENT OF WORK. NOTIFY TEXAS ONE CALL FOR UTILITY LOCATIONS PRIOR TO ANY & ALL EXCAVATIONS. COORDINATION OF ALL RELOCATION OF UTILITY POLES, ECT. TO BE THE RESPONSIBILITY OF THE CONTRACTOR.
- 14. CONTRACTOR TO COORDINATE WITH THE CITY OF KINGSVILLE ON WORK SCHEDULES, TESTING, GENERAL INSPECTION, AND EXISTING LINES.
- 15. CONTRACTOR TO EXERCISE CAUTION WHEN WORKING NEAR EXISTING FACILITIES AND/OR UTILITIES. ALL DAMAGE TO BE REPAIRED AT CONTRACTOR'S EXPENSE. ALL COSTS FOR INTERRUPTION OF GAS, ELECTRICAL, COMMUNICATIONS AND/OR WATER SERVICE DUE TO CONTRACTOR'S WORK SHALL BE BORNE BY THE CONTRACTOR.
- 16. INFORMATION ON EXISTING UTILITIES IS FROM BEST AVAILABLE INFORMATION OF RECORD AND SPOT FIELD LOCATIONS. CONTRACTOR IS RESPONSIBLE FOR FIELD LOCATION OF THESE UNDERGROUND UTILITIES AS REQUIRED AT NO SEPARATE PAY. CITY OF KINGSVILLE PERSONNEL WILL BE AVAILABLE FOR ASSISTANCE AND OPERATION OF VALVES AS REQUIRED. CONTRACTOR TO COORDINATE WITH OTHER UTILITY COMPANIES, INCLUDING AEP ON ELECTRICAL UTILITIES, CENTERPOINT ENERGY ON GAS UTILITIES AND SOUTHWESTERN BELL ON TELEPHONE UTILITIES.
- 17. ALL SPOIL MATERIAL AND DEBRIS SHALL BE DISPOSED OF BY CONTRACTOR. FURNISHING AND TRANSPORTATION OF ALL OFFSITE MATERIAL TO BE AT CONTRACTOR'S EXPENSE.

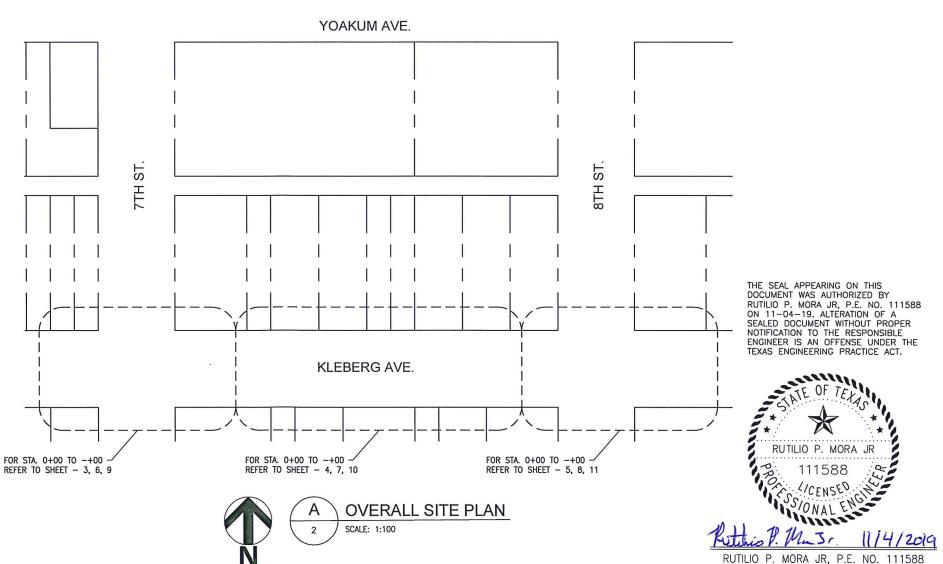
 18. UPON COMPLETION OF CONSTRUCTION, CONTRACTOR SHALL RETURN THE SITE TO ORIGINAL
- CONTOURS UNLESS DIFFERENT FINISHED ELEVATIONS ARE SHOWN ON PLANS. CONTRACTOR TO INSURE NO AREAS OF PONDING ARE PRESENT.
- 19. CONTRACTOR TO INSURE SAME DAY ACCESS TO SCHOOL, ALL RESIDENCES AND BUSINESSES ADJACENT TO CONSTRUCTION.
- DEMOLITION, REMOVAL & DISPOSAL OF ALL EXCESS CONCRETE, CURBS, RUBBLE, ETC. TO BE AT CONTRACTOR'S EXPENSE.
- 21. STREET & SUBGRADE EXCAVATION TO BE THE PROPERTY OF THE CITY AND TO BE STOCK PILED AT THE CITY OF KINGSVILLE LANDFILL AS DIRECTED BY THE CITY REPRESENTATIVE.

 22. CONCRETE NOTES:
- a) ALL CONCRETE WORK TO BE FORMED, UNLESS OTHERWISE APPROVED.
- b) ALL CONCRETE TO BE 3000 PSI MINIMUM AT 28 DAYS, UNLESS OTHERWISE SHOWN. STRENGTH TO BE DETERMINED BY CYLINDER BREAK TEST.
- c) ALL REINFORCING STEEL TO BE ASTM A-615, GRADE 60, UNLESS OTHERWISE SHOWN.
 d) ALL EXPOSED CONCRETE WORK TO BE CHAMFERED.
- 23. CONTRACTOR TO VERIFY THAT ALL CONCRETE SURFACES MEET THE FOLLOWING SLOPE CRITERIA PRIOR TO PLACEMENT OF CONCRETE.
 - a) RAMP SLOPE 12:1 (8.33%) (MAX)
 - b) RUNNING SLOPE 20:1 (5%) (MAX)
 - c) CROSS SLOPE 50:1 (2%) (MAX)
- (CROSS SLOPE IS SLOPE PÉRPENDICULAR TO THE DIRECTION OF TRAVEL.)

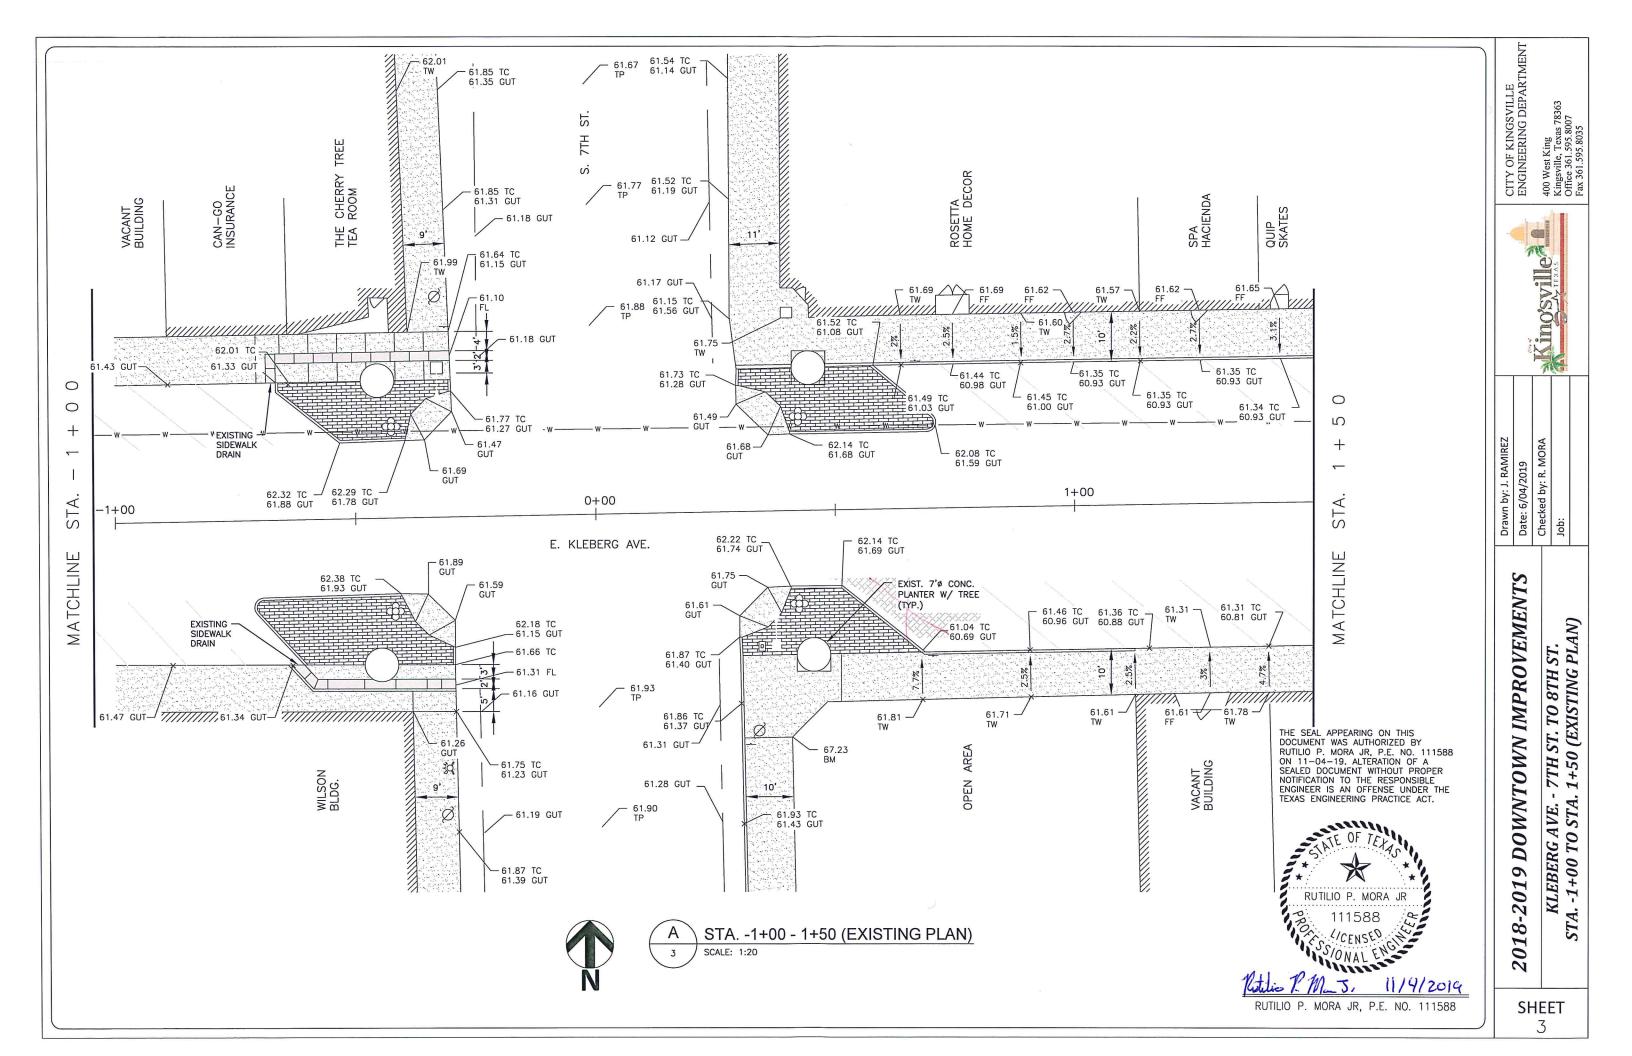
 24. CONTRACTOR SHALL BE RESPONSIBLE FOR PLACING SILT FENCE IN AREAS OF DISTURBED SOIL TO PREVENT EROSION FROM ENTERING DRIVEWAYS.

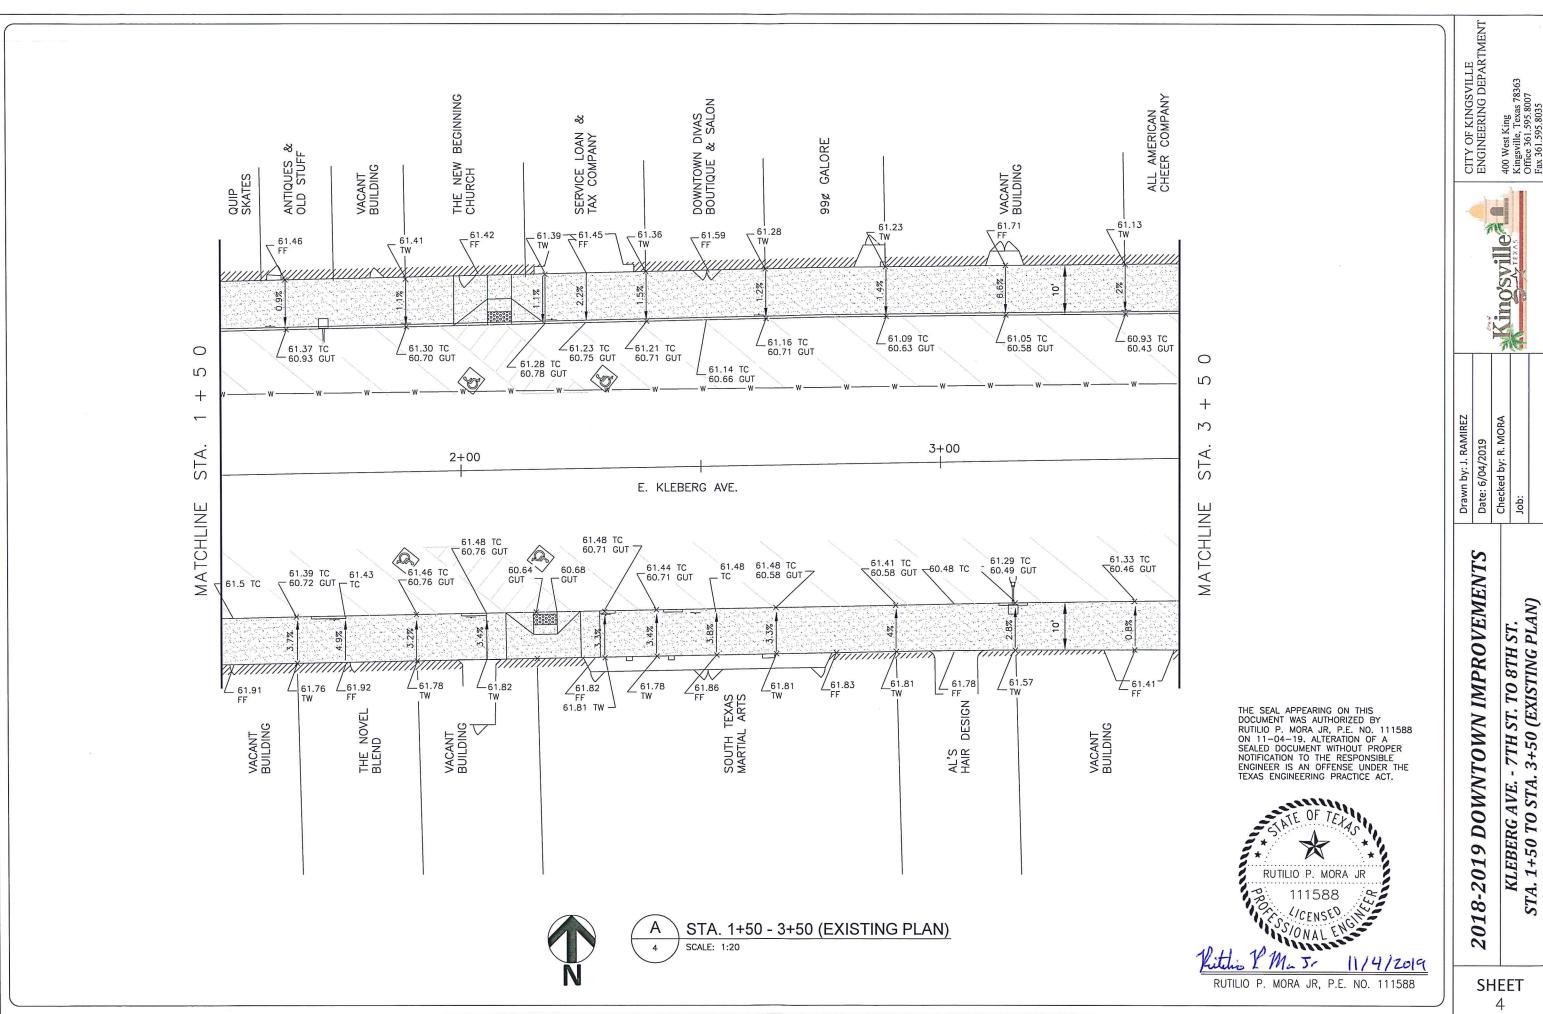


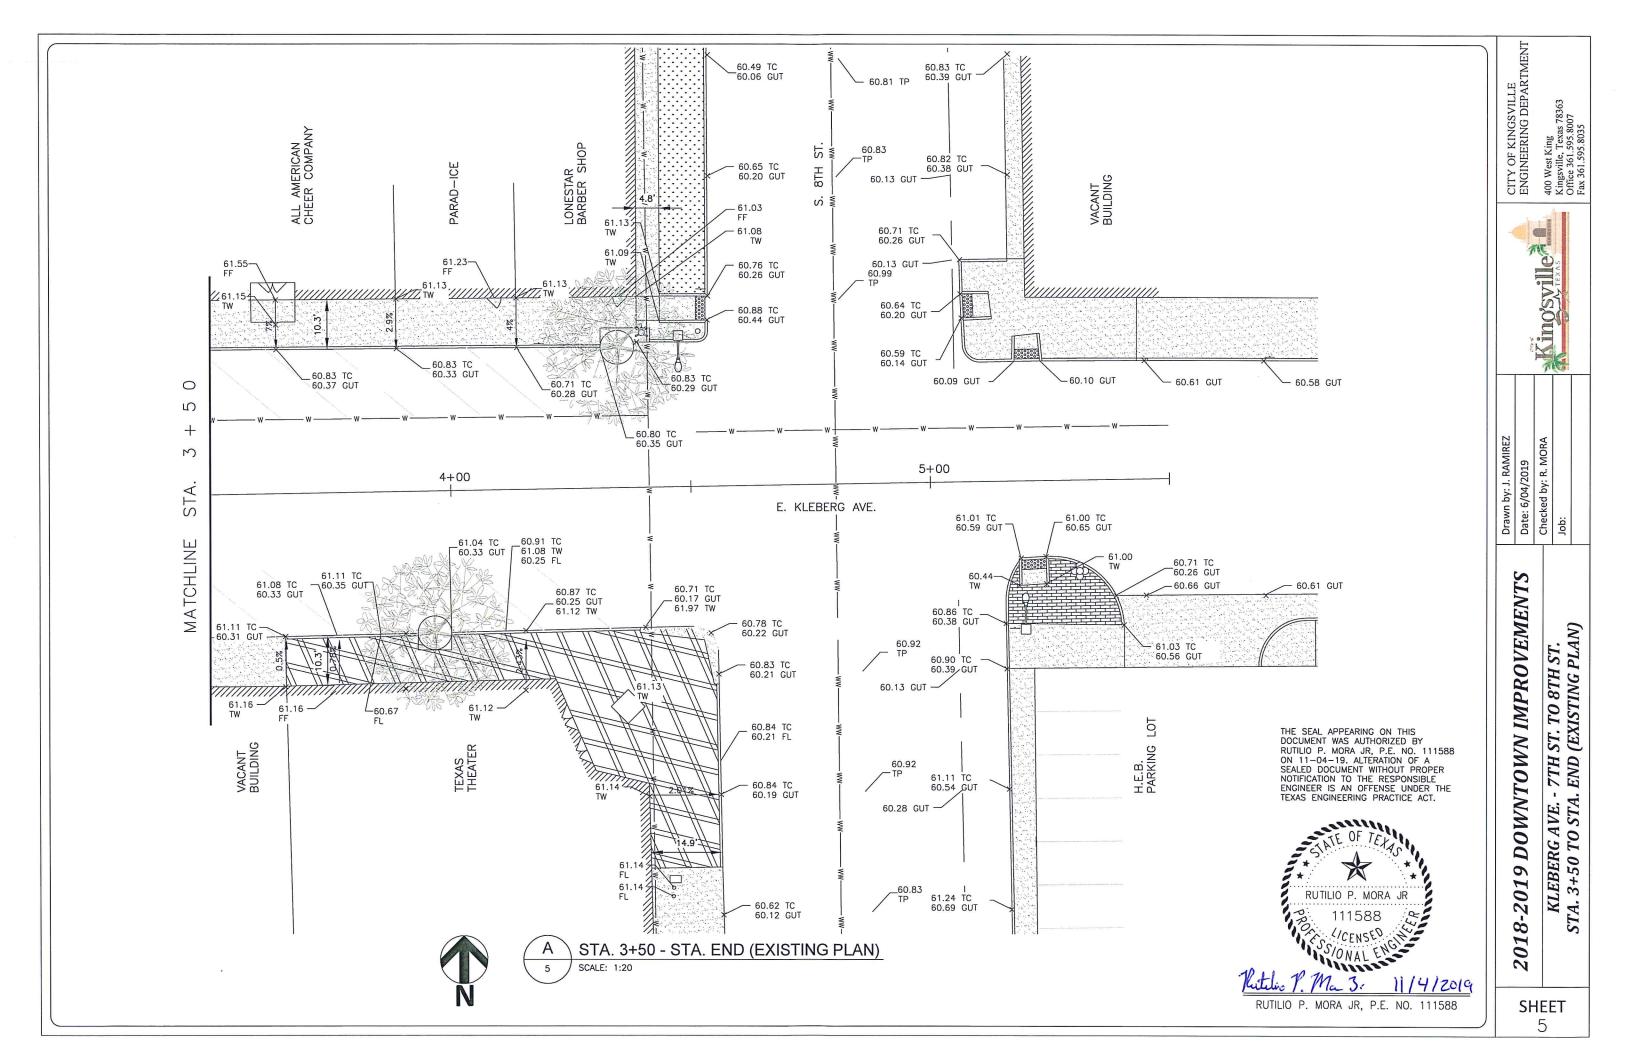


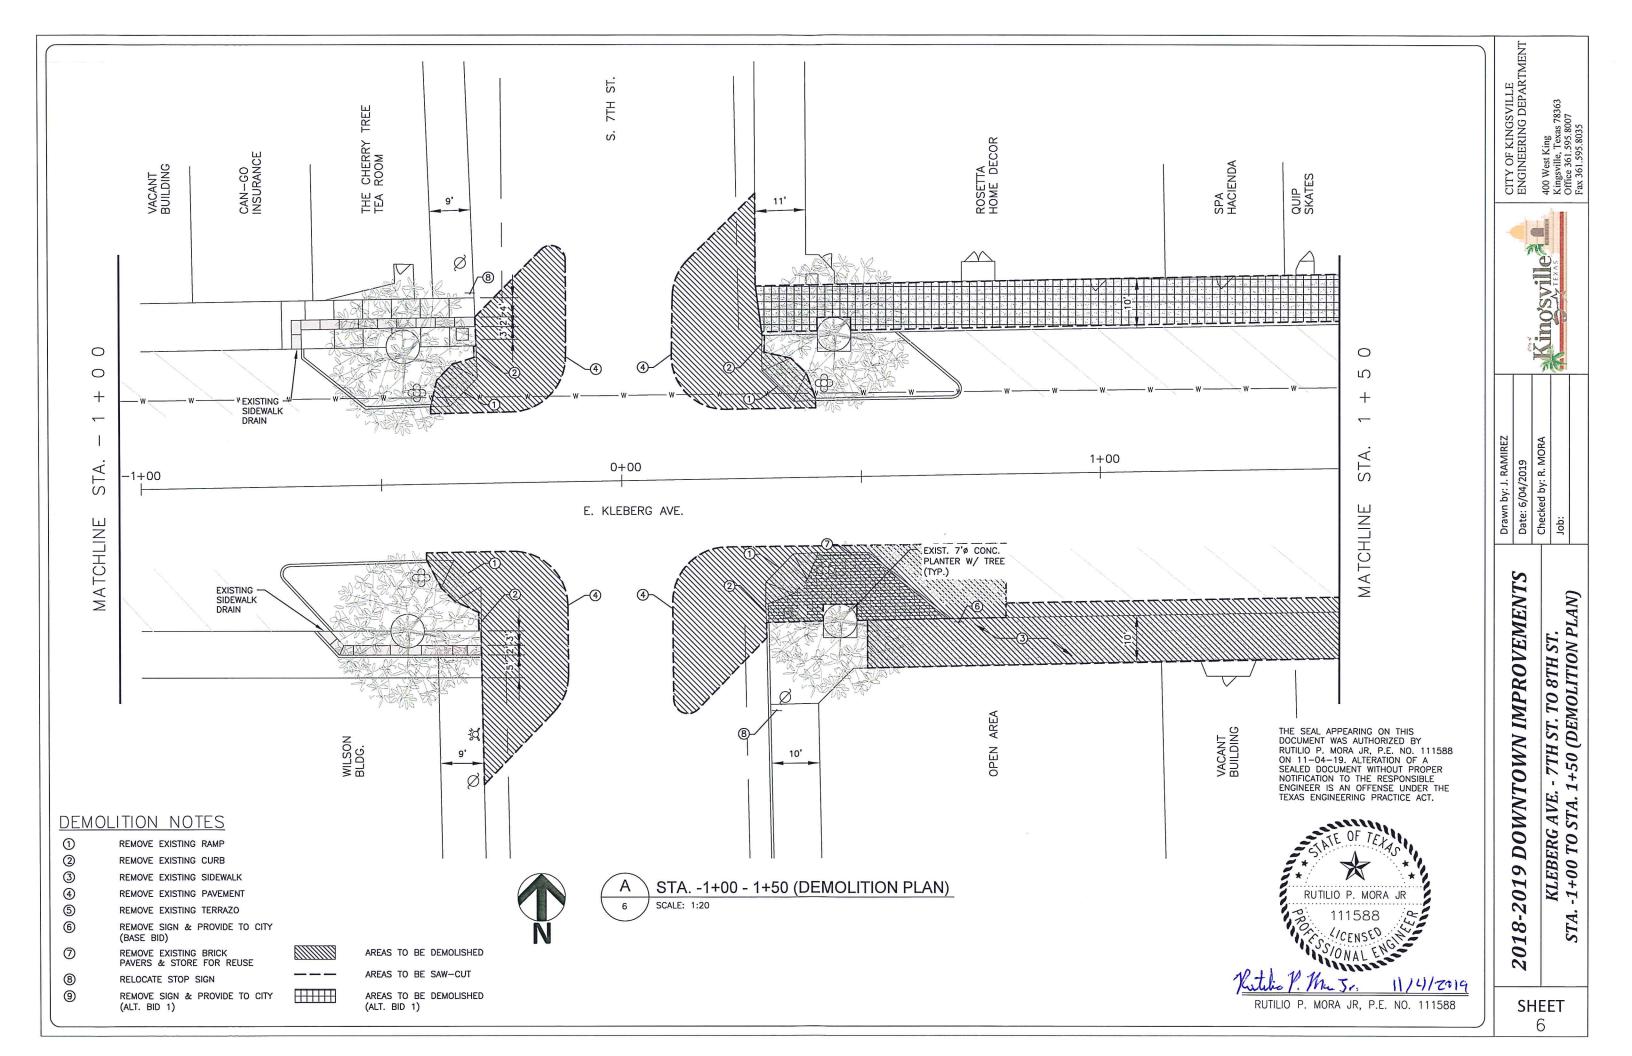


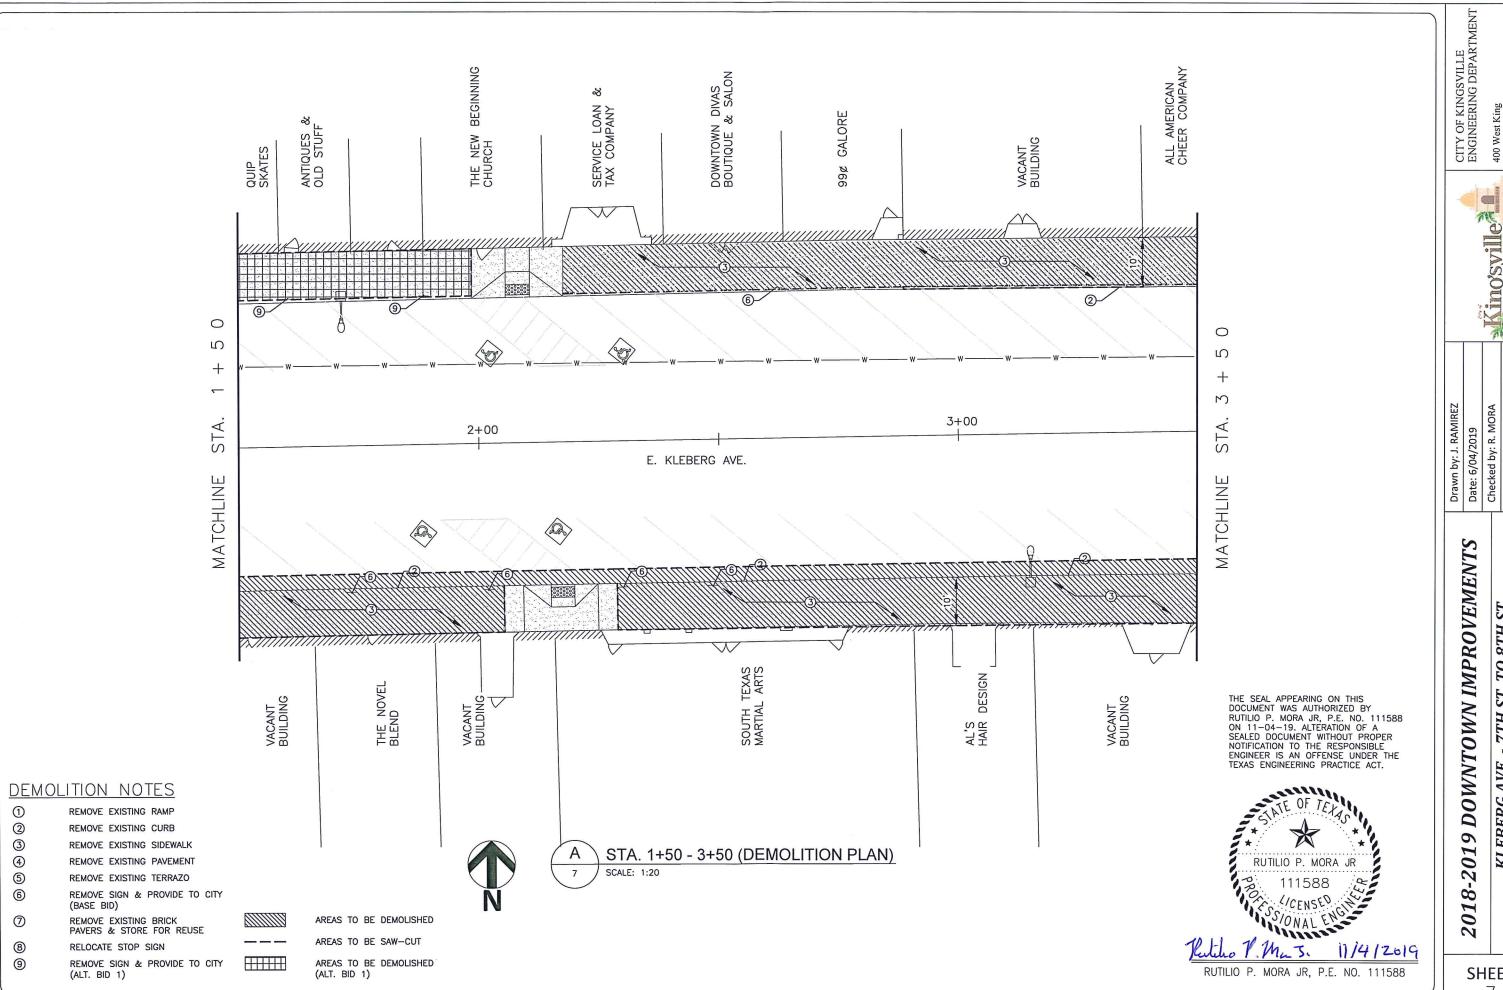
CITY OF KINGSVILLE ENGINEERING DEPAR Kingsville *IMPROVEMENTS* PLAN SITE OVERALL DOWNTOWN 8 NOTES GENERAL 6 201 8 01 N







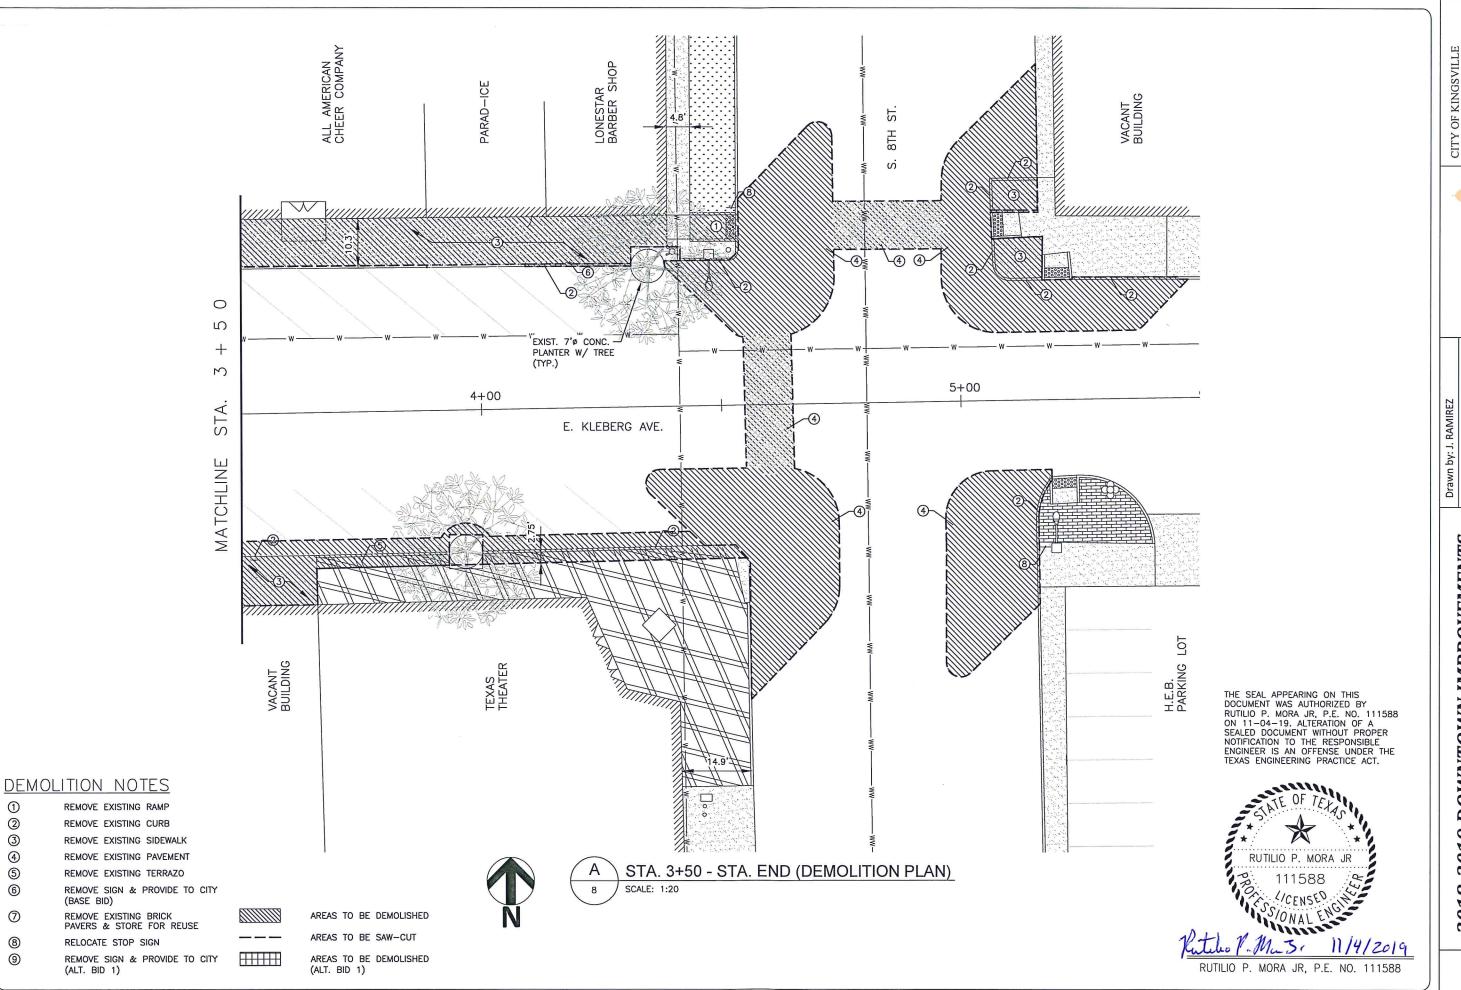




400 West King Kingsville, Texas 78363 Office 361.595.8007 Fax 361.595.8035

Kingsville

KLEBERG AVE. - 7TH ST. TO 8TH ST. STA. 1+50 TO STA. 3+50 (DEMOLITION PLAN)



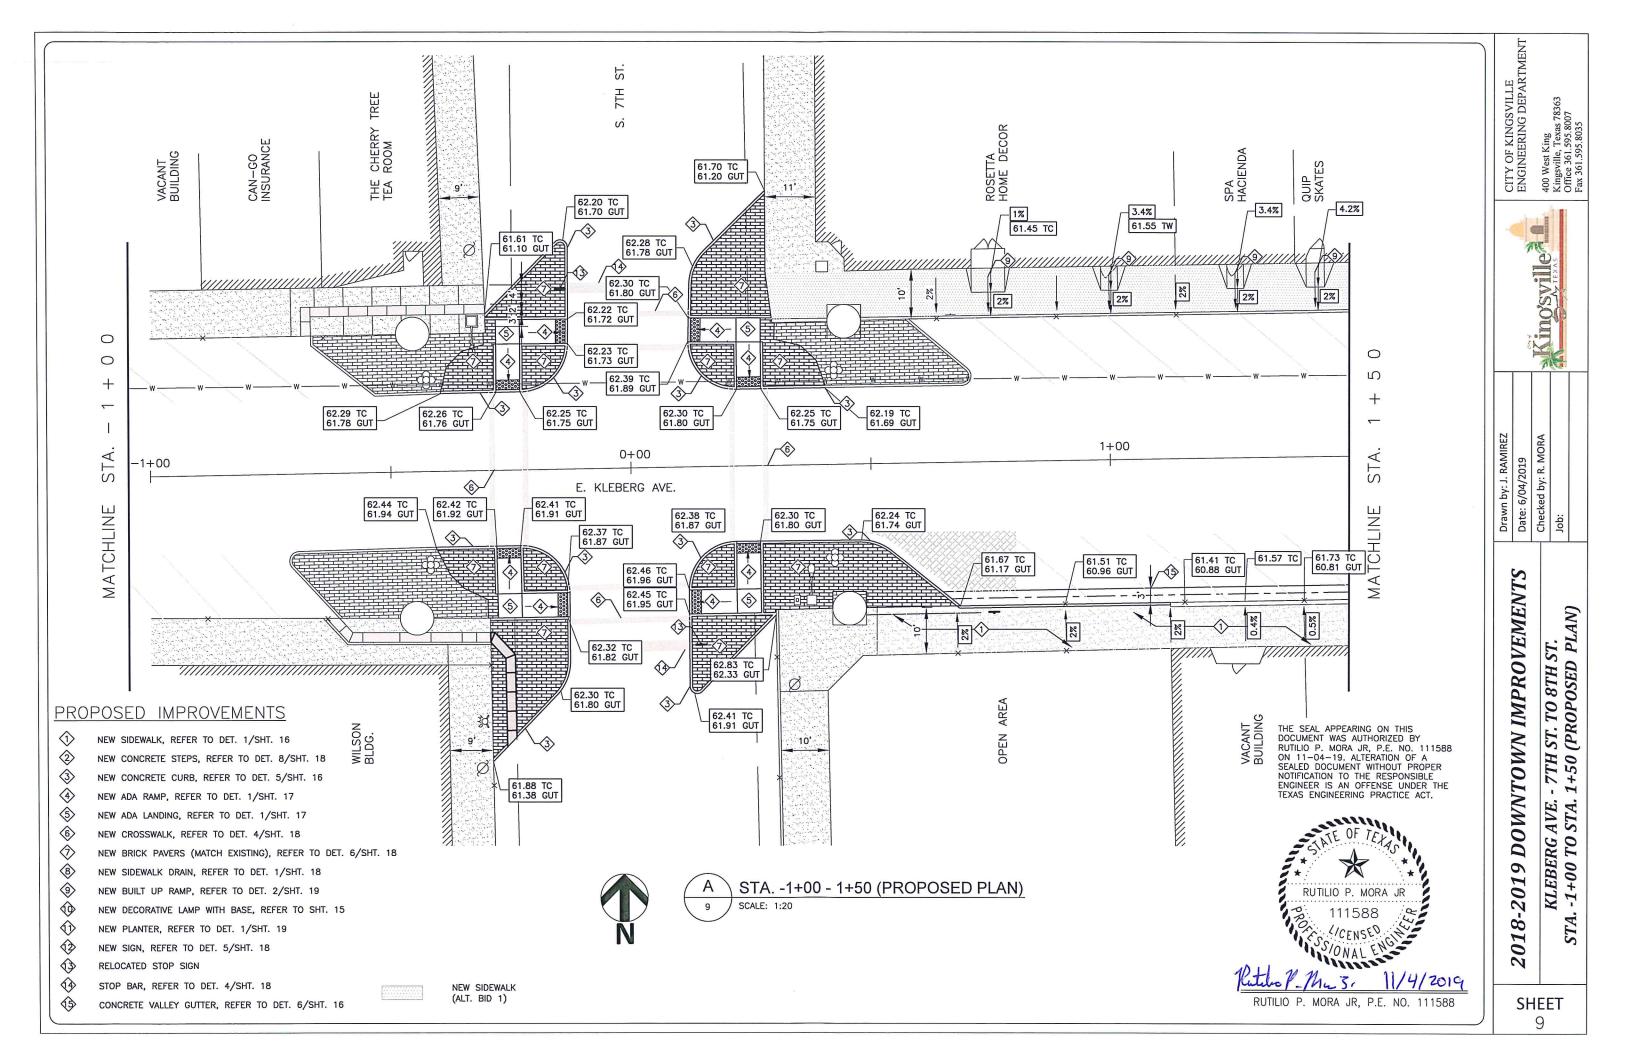
CITY OF KINGSVILLE
ENGINEERING DEPARTMENT
400 West King
Kingsville, Texas 78363
Office 361.595.8007
Fax 361.595.8035

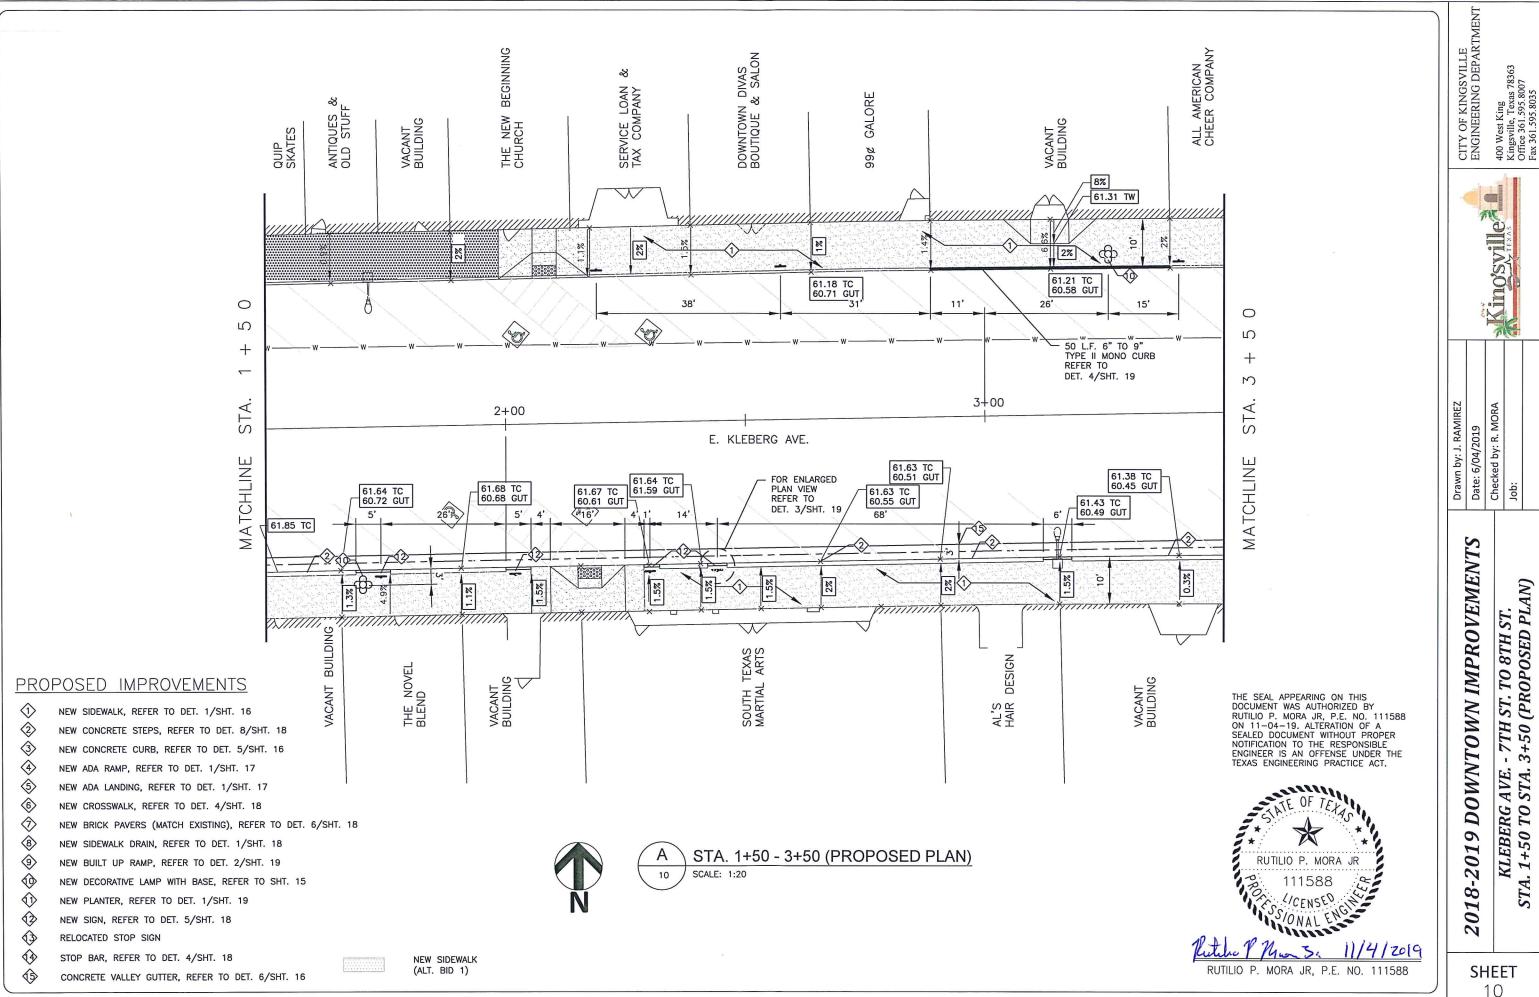
Drawn by: J. RAMIREZ
Date: 6/04/2019
Checked by: R. MORA
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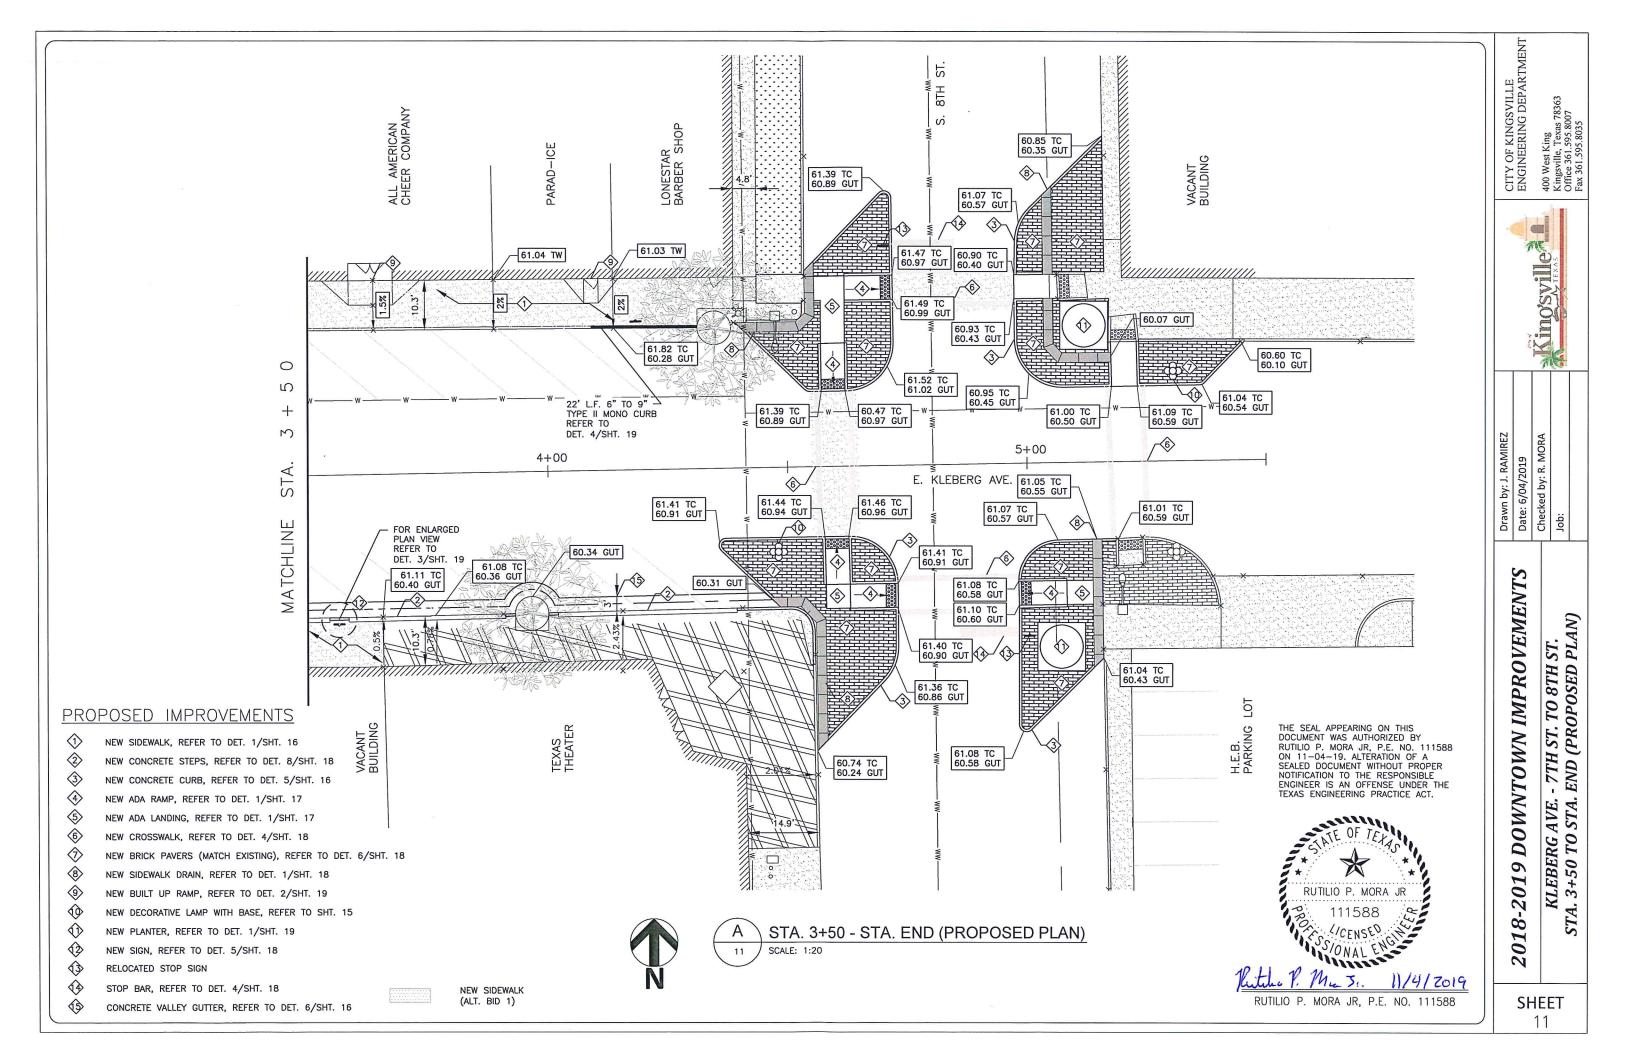
2018-2019 DOWNTOWN IMPROVEMENTS

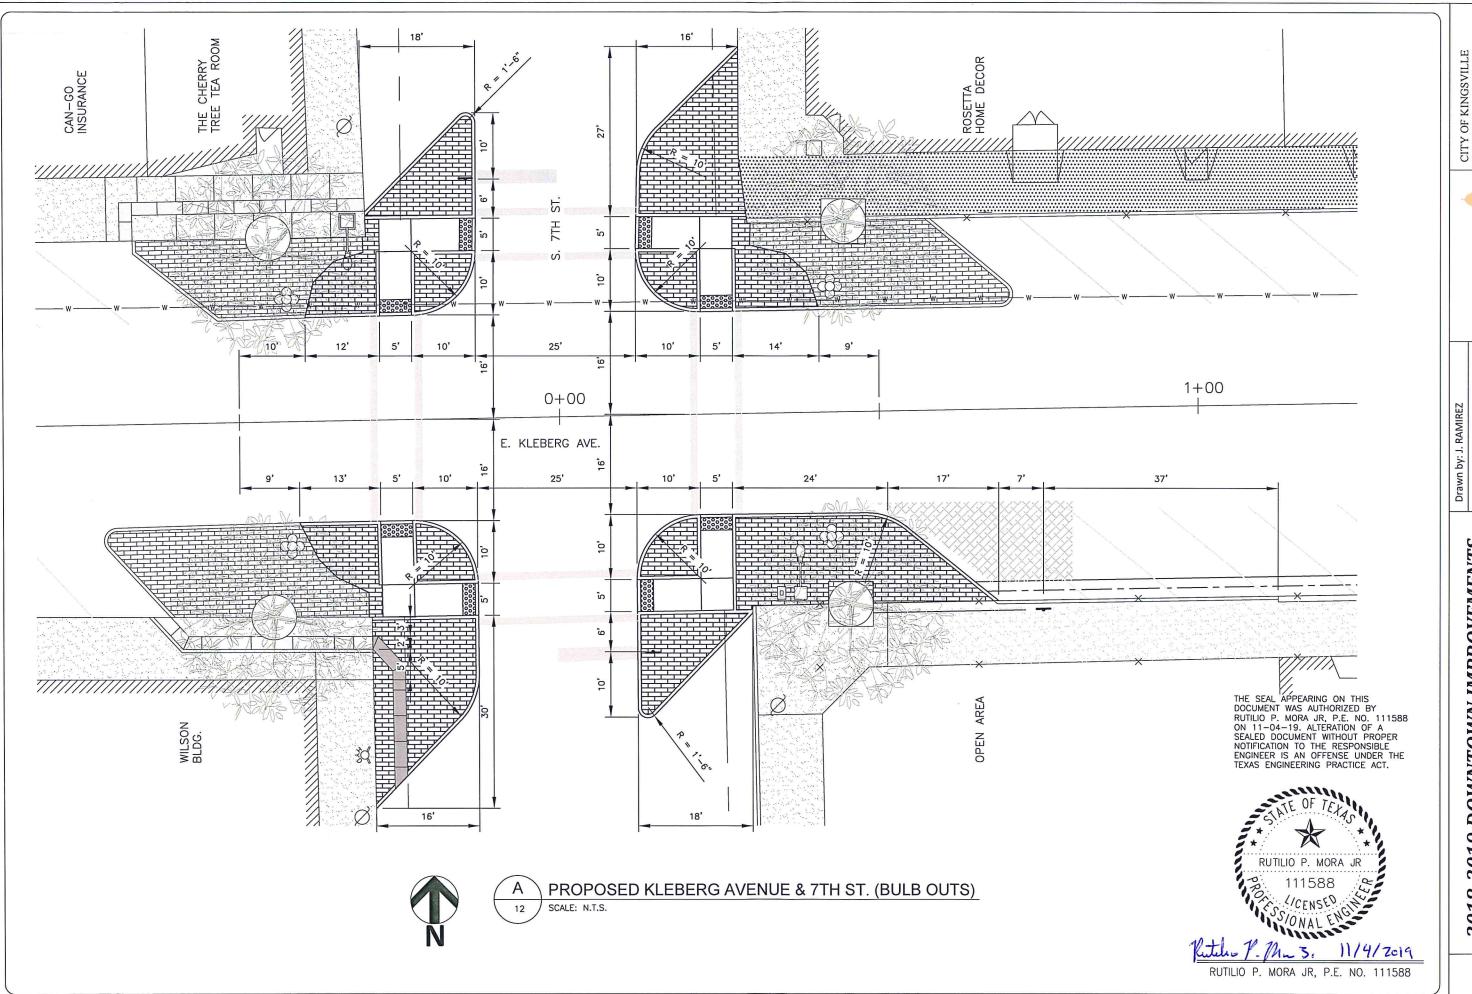
KLEBERG AVE. - 7TH ST. TO 8TH ST.

STA. 3+50 TO STA. END (DEMOLITION PLAN)









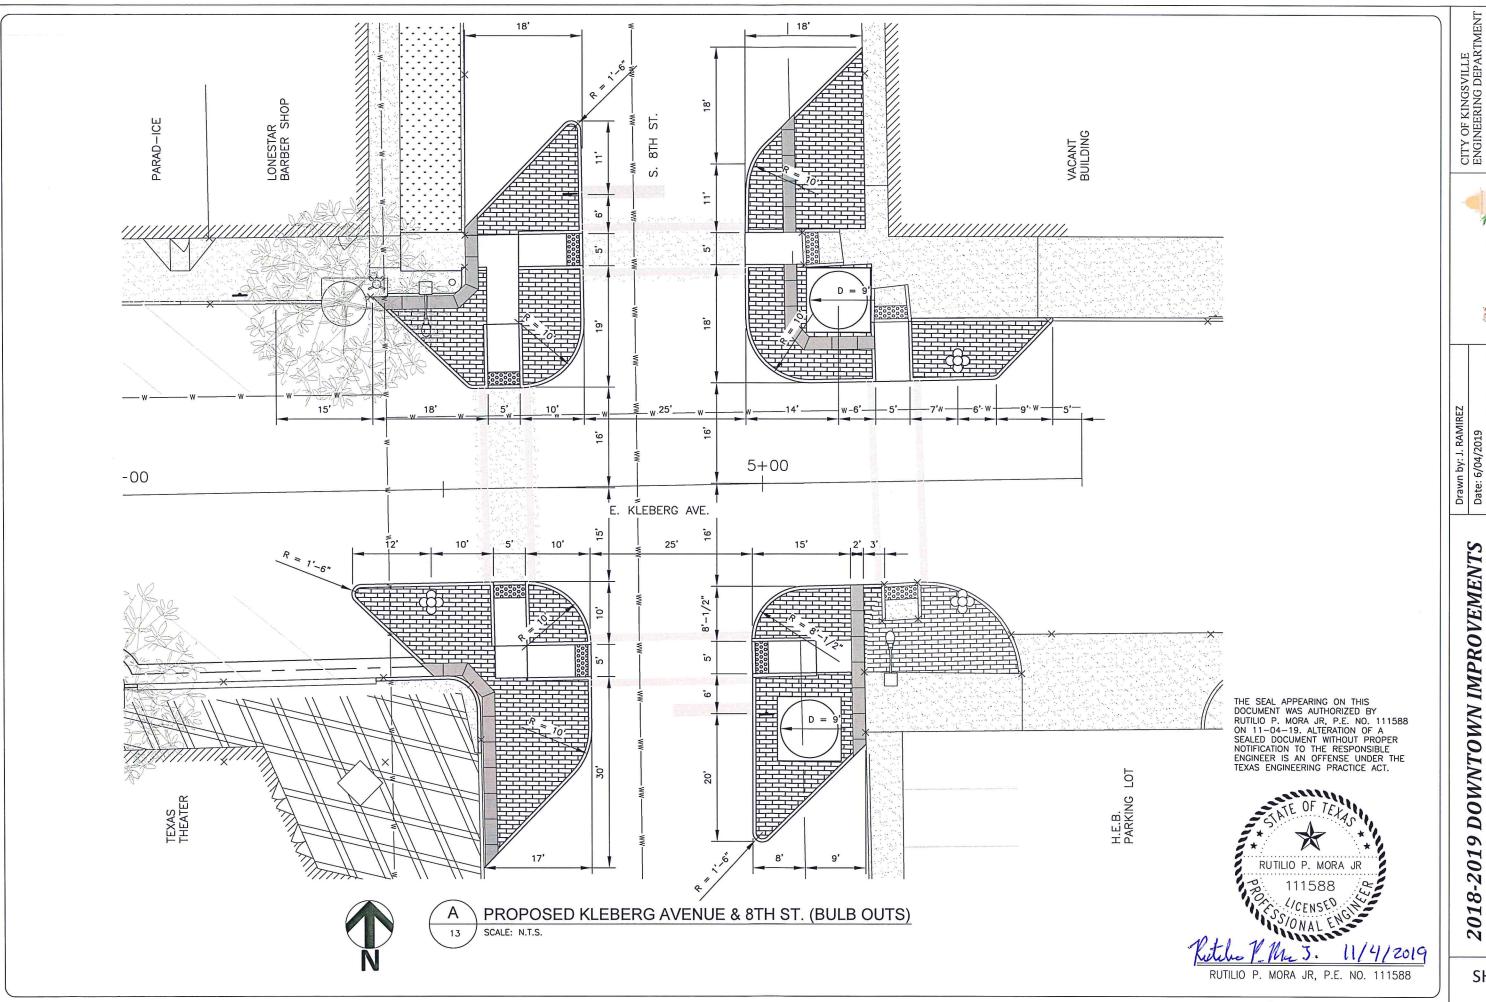
CITY OF KINGSVILLE ENGINEERING DEPARTMENT

Kingsville

Drawn by: J. RAMIREZ
Date: 6/04/2019
Checked by: R. MORA

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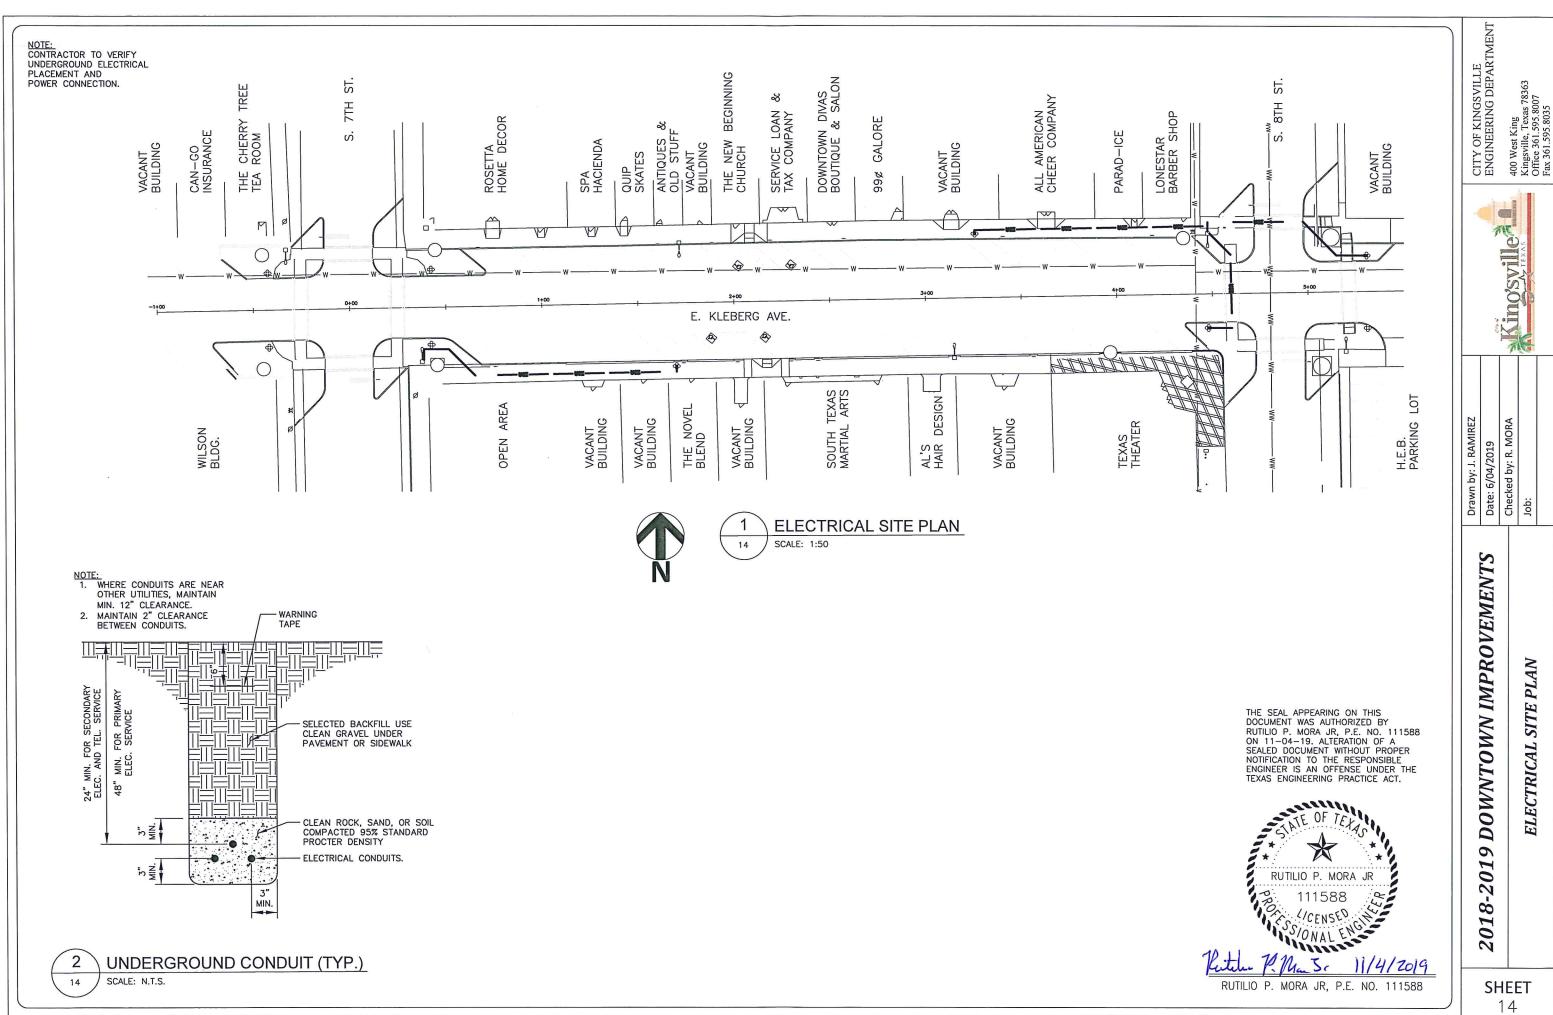
KLEBERG AVE. - 7TH ST. TO 8TH ST. PROPOSED KLEBERG AVENUE & 7TH ST. (BULB OUTS)

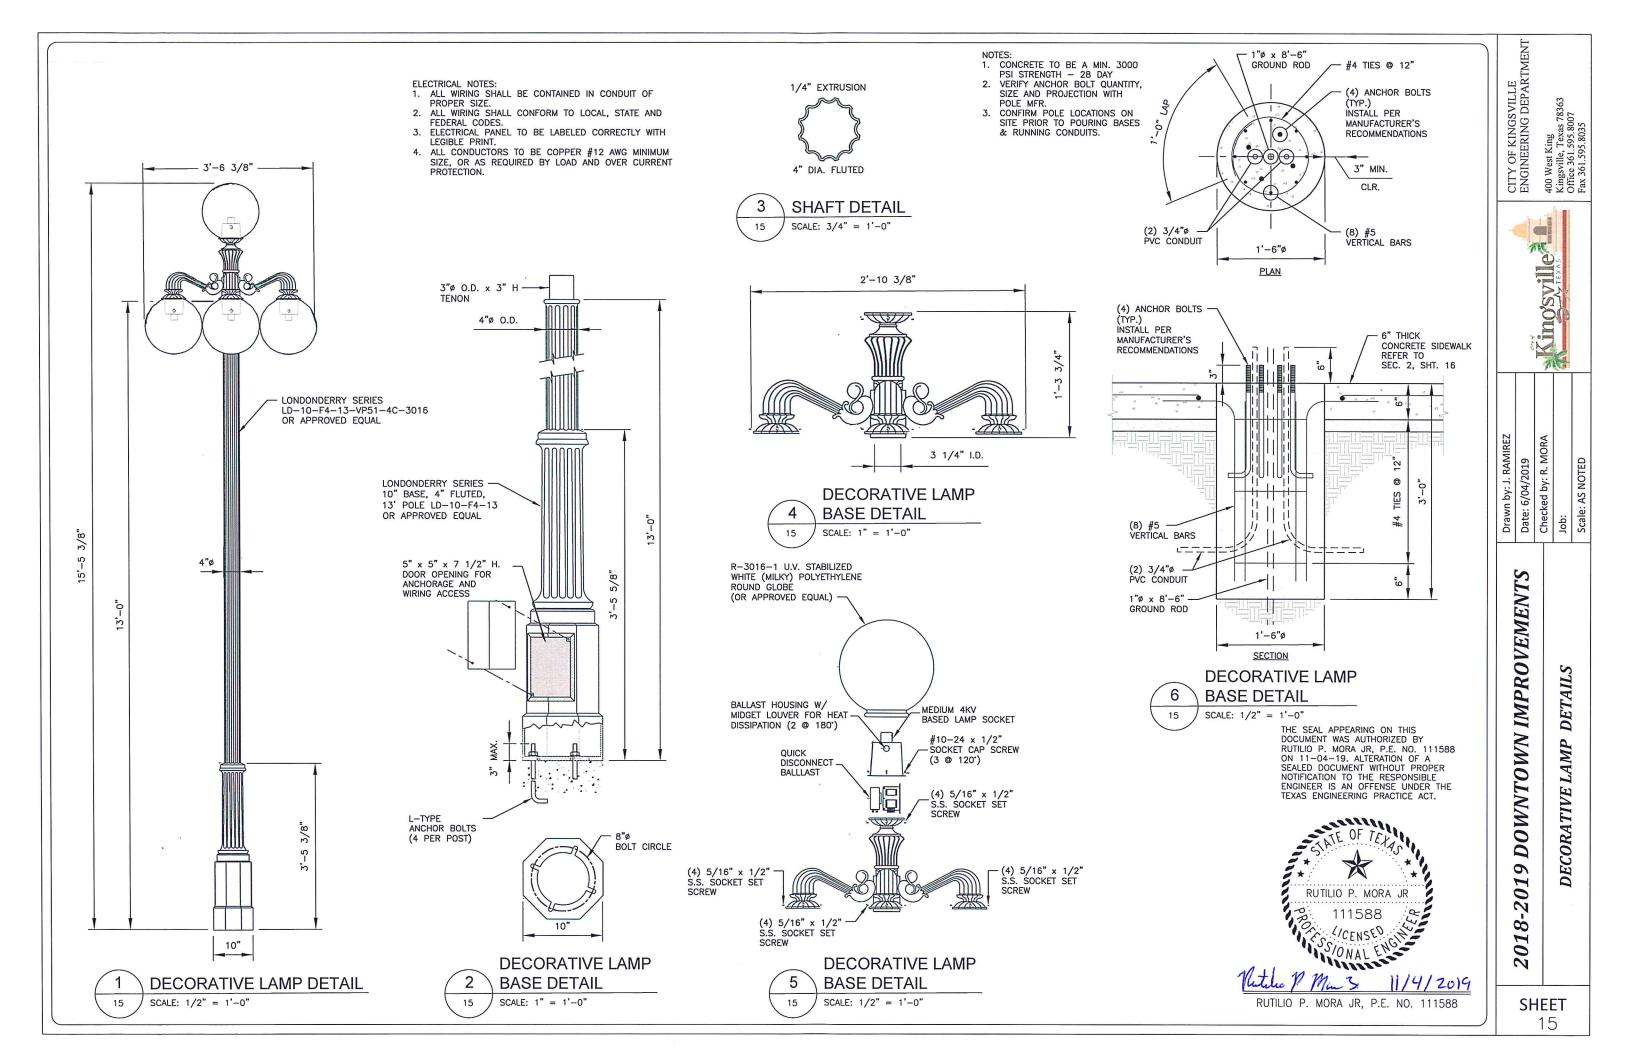


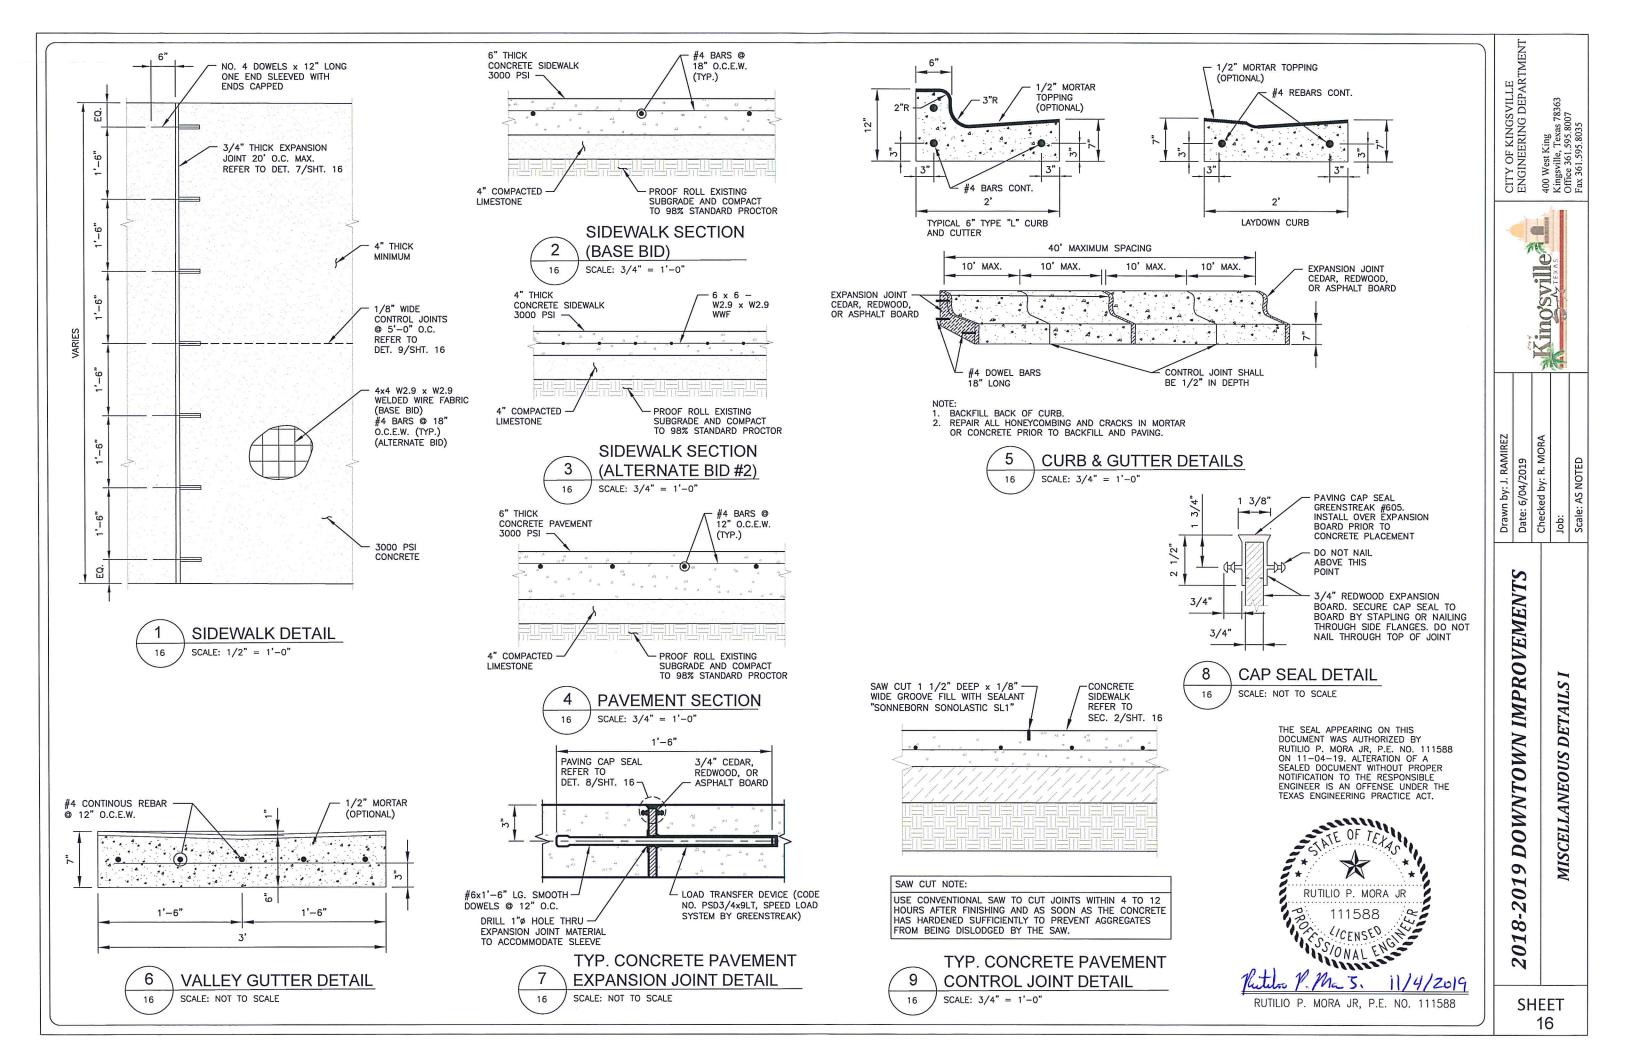
Kingsville

Drawn by: J. RAMIREZ
Date: 6/04/2019
Checked by: R. MORA

KLEBERG AVE. - 7TH ST. TO 8TH ST. PROPOSED KLEBERG AVENUE & 8TH ST. (BULB OUTS)







CURB RAMPS

- INSTALL A CURB RAMP OR BLENDED TRANSITION AT EACH PEDESTRIAN STREET CROSSING.
- ALL SLOPES SHOWN ARE MAXIMUM ALLOWABLE. CROSS SLOPES OF 1.5% AND LESSER RUNNING SHOULD BE USED. ADJUST CURB RAMP LENGTH OR GRADE OF APPROACH SIDEWALKS AS DIRECTED.
- MAXIMUM ALLOWABLE CROSS SLOPE ON SIDEWALK AND CURB RAMP SURFACES IS 2%.
- 4. THE MINIMUM SIDEWALK WIDTH IS 5'. WHERE THE SIDEWALK IS ADJACENT TO THE BACK OF CURB, A 6' SIDEWALK WIDTH IS DESIRABLE. WHERE A 5' SIDEWALK CANNOT BE PROVIDED DUE TO SITE CONSTRAINTS, SIDEWALK WIDTH MAY BE REDUCED TO 4' FOR SHORT DISTANCES. 5' X 5' PASSING AREAS AT INTERVALS NOT TO EXCEED 200' ARE REQUIRED.
- 5. TURNING SPACES SHALL BE 5' X 5' MINIMUM. CROSS SLOPE SHALL BE MAXIMUM 2%
- CLEAR SPACE AT THE BOTTOM OF CURB RAMPS SHALL BE A MINIMUM OF 4' X 4' WHOLLY CONTAINED WITHIN THE CROSSWALK AND WHOLLY OUTSIDE THE PARALLEL VEHICULAR TRAVEL PATH.
- 7. PROVIDE FLARED SIDES WHERE THE PEDESTRIAN CIRCULATION PATH CROSSES THE CURB RAMP, FLARED SIDES SHALL BE SLOPED AT 10% MAXIMUM, MEASURED PARALLEL TO THE CURB. RETURNED CURBS MAY BE USED ONLY WHERE PEDESTRIANS WOULD NOT NORMALLY WALK ACROSS THE RAMP, EITHER BECAUSE THE ADJACENT SURFACE IS PLANTED, SUBSTANTIALLY OBSTRUCTED, OR OTHERWISE PROTECTED.
- 8. ADDITIONAL INFORMATION ON CURB RAMP LOCATION, DESIGN, LIGHT REFLECTIVE VALUE AND TEXTURE MAY BE FOUND IN THE LATEST DRAFT OF THE PROPOSED GUIDELINES FOR PEDESTRIAN FACILITIES IN THE PUBLIC RIGHT OF WAY (PROWAG) AS PUBLISHED BY THE U.S. ARCHITECTURAL AND TRANSPORTATION BARRIERS COMPLIANCE BOARD (ACCESS BOARD).
- TO SERVE AS A PEDESTRIAN REFUGE AREA, THE MEDIAN SHOULD BE A MINIMUM OF 6' WIDE, MEASURED FROM BACK OF CURBS. MEDIANS SHOULD BE DESIGNED TO PROVIDE ACCESSIBLE PASSAGE OVER OR THROUGH THEM.
- 10. SMALL CHANNELIZATION ISLANDS, WHICH DO NOT PROVIDE A MINIMUM 5'X 5' LANDING AT THE TOP OF CURB RAMPS, SHALL BE CUT THROUGH LEVEL WITH THE SURFACE OF THE STREET.
- 11. CROSSWALK DIMENSIONS, CROSSWALK MARKINGS AND STOP BAR LOCATIONS SHALL BE AS SHOWN ELSEWHERE IN THE PLANS. AT INTERSECTIONS WHERE CROSSWALK MARKINGS ARE NOT REQUIRED, CURB RAMPS SHALL ALIGN WITH THEORETICAL CROSSWALKS UNLESS OTHERWISE DIRECTED.
- 12. PROVIDE CURB RAMPS TO CONNECT THE PEDESTRIAN ACCESS ROUTE AT EACH PEDESTRIAN STREET CROSSING. HANDRAILS ARE NOT REQUIRED ON CURB RAMPS.
- CURB RAMPS AND LANDINGS SHALL BE CONSTRUCTED AND PAID FOR IN ACCORDANCE WITH ITEM 531 "SIDEWALKS".
- PLACE CONCRETE AT A MINIMUM DEPTH OF 5" FOR RAMPS, FLARES AND LANDINGS, UNLESS OTHERWISE DIRECTED.
- 15. FURNISH AND INSTALL NO. 3 REINFORCING STEEL BARS AT 18" O.C. BOTH WAYS, UNLESS OTHERWISE DIRECTED.
- 16. PROVIDE A SMOOTH TRANSITION WHERE THE CURB RAMPS CONNECT TO THE STREET.
- 17. EXISTING FEATURES THAT COMPLY WITH APPLICABLE STANDARDS MAY REMAIN IN PLACE UNLESS OTHERWISE SHOWN ON THE PLANS.

DETECTABLE WARNING MATERIAL

- CURB RAMPS MUST CONTAIN A DETECTABLE WARNING SURFACE THAT CONSISTS OF RAISED TRUNCATED DOMES COMPLYING WITH PROWAG. THE SURFACE MUST CONTRAST VISUALLY WITH ADJOINING SURFACES, INCLUDING SIDE FLARES. FURNISH AND INSTALL AN APPROVED CAST—IN—PLACE DARK BROWN OR DARK RED DETECTABLE WARNING SURFACE MATERIAL ADJACENT TO UNCOLORED CONCRETE, UNLESS SPECIFIED ELSEWHERE IN THE PLANS.
- 2. DETECTABLE WARNING MATERIALS MUST MEET TXDOT DEPARTMENTAL MATERIALS SPECIFICATION DMS 4350 AND BE LISTED ON THE MATERIAL PRODUCER LIST. INSTALL PRODUCTS IN ACCORDANCE WITH MANUFACTURER'S SPECIFICATIONS.
- 3. DETECTABLE WARNING SURFACES MUST BE FIRM, STABLE AND SLIP RESISTANT.
- 4. DETECTABLE WARNING SURFACES SHALL BE A MINIMUM OF 24 INCHES IN DEPTH IN THE DIRECTION OF PEDESTRIAN TRAVEL, AND EXTEND THE FULL WIDTH OF THE CURB RAMP OR LANDING WHERE THE PEDESTRIAN ACCESS ROUTE ENTERS THE STREET.
- 5. DETECTABLE WARNING SURFACES SHALL BE LOCATED SO THAT THE EDGE NEAREST THE CURB LINE IS AT THE BACK OF CURB AND NEITHER END OF THAT EDGE IS GREATER THAN 5 FEET FROM THE BACK OF CURB. DETECTABLE WARNING SURFACES MAY BE CURVED ALONG THE CORNER RADIUS.
- 6. SHADED AREAS ON SHEET 1 OF 4 INDICATE THE APPROXIMATE LOCATION FOR THE DETECTABLE WARNING SURFACE FOR EACH CURB RAMP TYPE.

DETECTABLE WARNING PAVERS (IF USED)

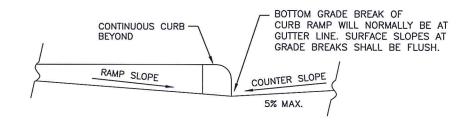
- FURNISH DETECTABLE WARNING PAVER UNITS MEETING ALL REQUIREMENTS OF ASTM C-936, C-33. LAY IN A TWO BY TWO UNIT BASKET WEAVE PATTERN OR AS DIRECTED.
- LAY FULL—SIZE UNITS FIRST FOLLOWED BY CLOSURE UNITS CONSISTING OF AT LEAST 25 PERCENT (25%) OF A FULL UNIT. CUT DETECTABLE WARNING PAVER UNITS USING A POWER SAW.

SIDEWALKS

- PROVIDE CLEAR GROUND SPACE AT OPERABLE PARTS, INCLUDING PEDESTRIAN PUSH BUTTONS. OPERABLE PARTS SHALL BE PLACED WITHIN UNOBSTRUCTED REACH RANGE SPECIFIED IN PROWAG SECTION R406.
- PLACE TRAFFIC SIGNAL OR ILLUMINATION POLES, GROUND BOXES, CONTROLLER BOXES, SIGNS, DRAINAGE FACILITIES AND OTHER ITEMS SO AS NOT TO OBSTRUCT THE PEDESTRIAN ACCESS ROUTE OR CLEAR GROUND SPACE.
- 3. STREET GRADES AND CROSS SLOPES SHALL BE AS SHOWN ELSEWHERE IN THE PLANS.
- . CHANGES IN LEVEL GREATER THAN 1/4 INCH ARE NOT PERMITTED.
- 5. THE LEAST POSSIBLE GRADE SHOULD BE USED TO MAXIMIZE ACCESSIBILITY. THE RUNNING SLOPE OF SIDEWALKS AND CROSSWALKS WITHIN THE PUBLIC RIGHT OF WAY MAY FOLLOW THE GRADE OF THE PARALLEL ROADWAY. WHERE A CONTINUOUS GRADE GREATER THAN FIVE PERCEDT (5%) MUST BE PROVIDED, HANDRAILS MAY BE DESIRABLE TO IMPROVE ACCESSIBILITY. HANDRAILS MAY ALSO BE NEEDED TO PROTECT PEDESTRIANS FROM POTENTIALLY HAZARDOUS CONDITIONS. IF PROVIDED, HANDRAILS SHALL COMPLY WITH PROWAG R409.
- HANDRAIL EXTENSIONS SHALL NOT PROTRUDE INTO THE USABLE LANDING AREA OR INTO INTERSECTING PEDESTRIAN ROUTES.
- DRIVEWAYS AND TURNOUTS SHALL BE CONSTRUCTED AND PAID FOR IN ACCORDANCE WITH ITEM "INTERSECTIONS, DRIVEWAYS AND TURNOUTS". SIDEWALKS SHALL BE CONSTRUCTED AND PAID FOR IN ACCORDANCE WITH ITEM, "SIDEWALKS".
- 8. SIDEWALK DETAILS ARE SHOWN ELSEWHERE IN THE PLANS.

TURNING
FLARE
S'
GRADE BREAK
(TYP.)



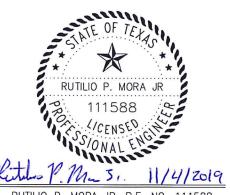


TYP. SECTION OF PERPENDICULAR

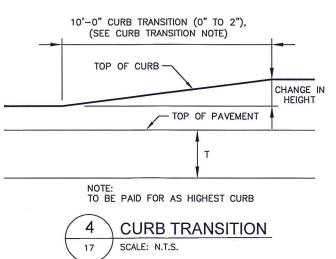
CURB RAMP AT CONNECTION TO ROADWAY

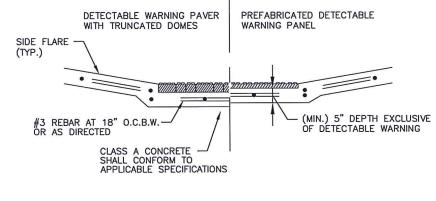
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CURB TRANSITION NOTE: FIELD CONDITIONS MAY REQUIRE A LONGER OR SHORTER TRANSITION, AND SHALL BE SHOWN ELSEWHERE IN THE PLANS, OR AS DIRECTED BY THE ENGINEER.





CURB RAMP DETAIL @
DETECTIBLE WARNINGS

17 SCALE: N.T.S.

RUTILIO P. MORA JR, P.E. NO. 111588

SHEET 17

CITY OF KINGSVILLE ENGINEERING DEPARTMENT

CIII

Kingsvill

RAMIREZ

Date: 6, Checke

DOWNTOWN IMPROVEMENTS

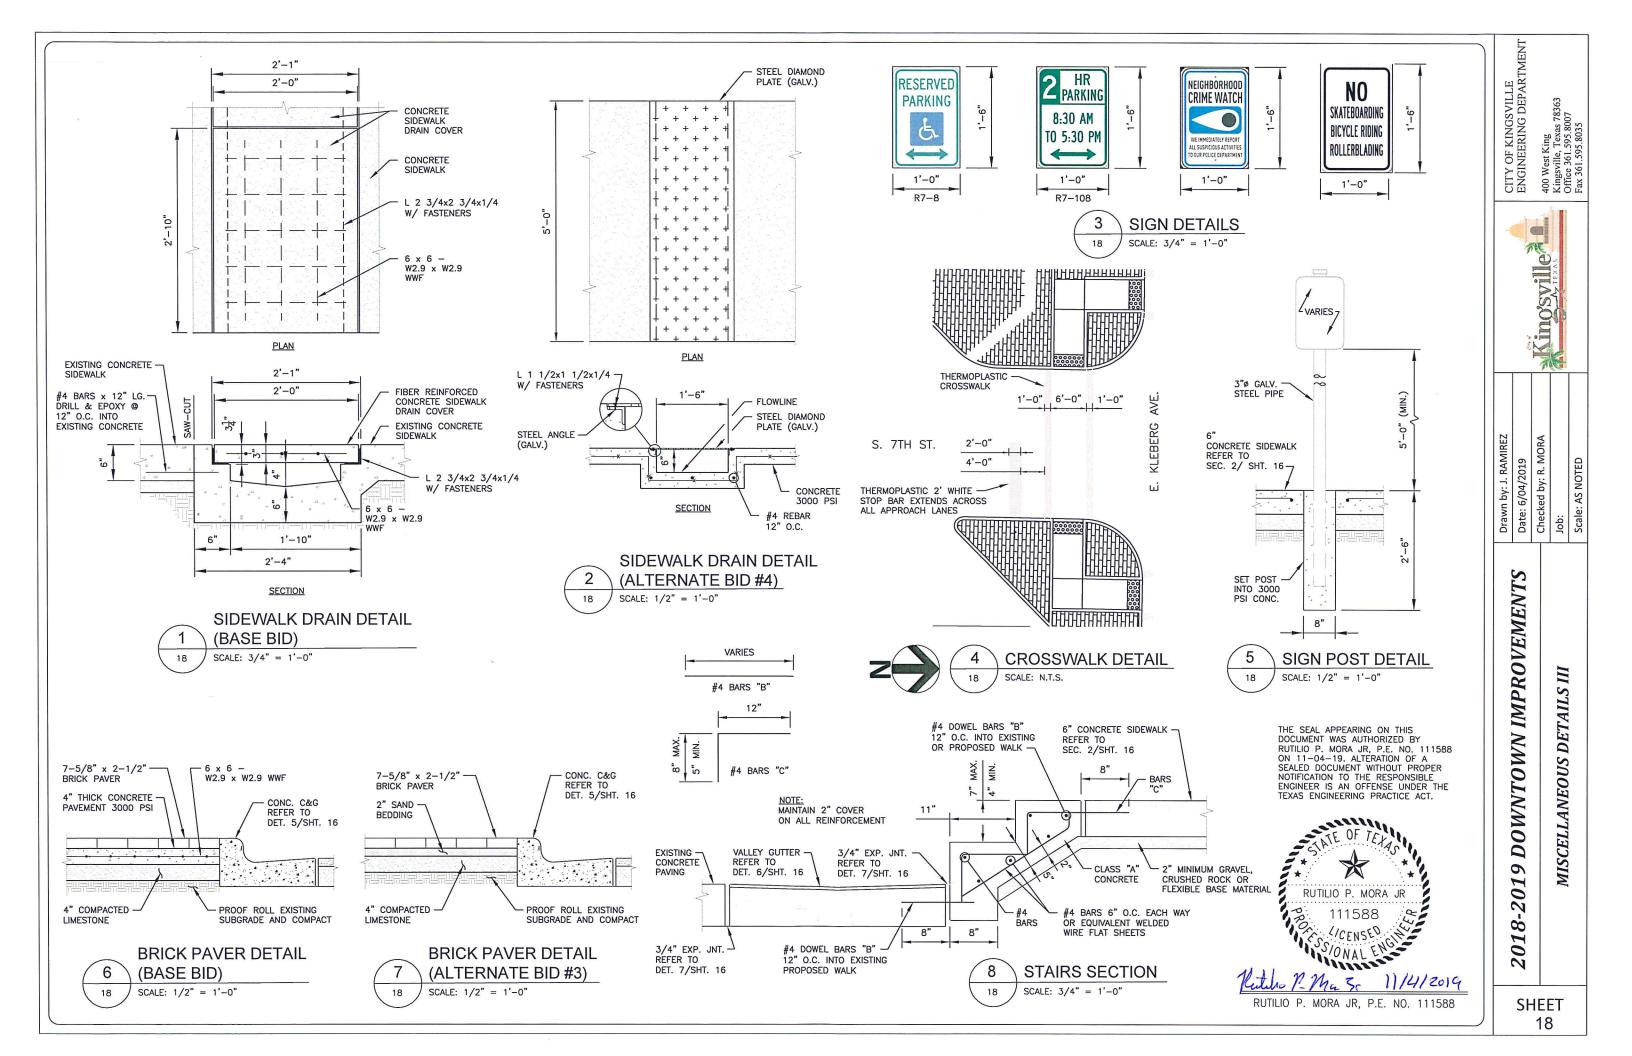
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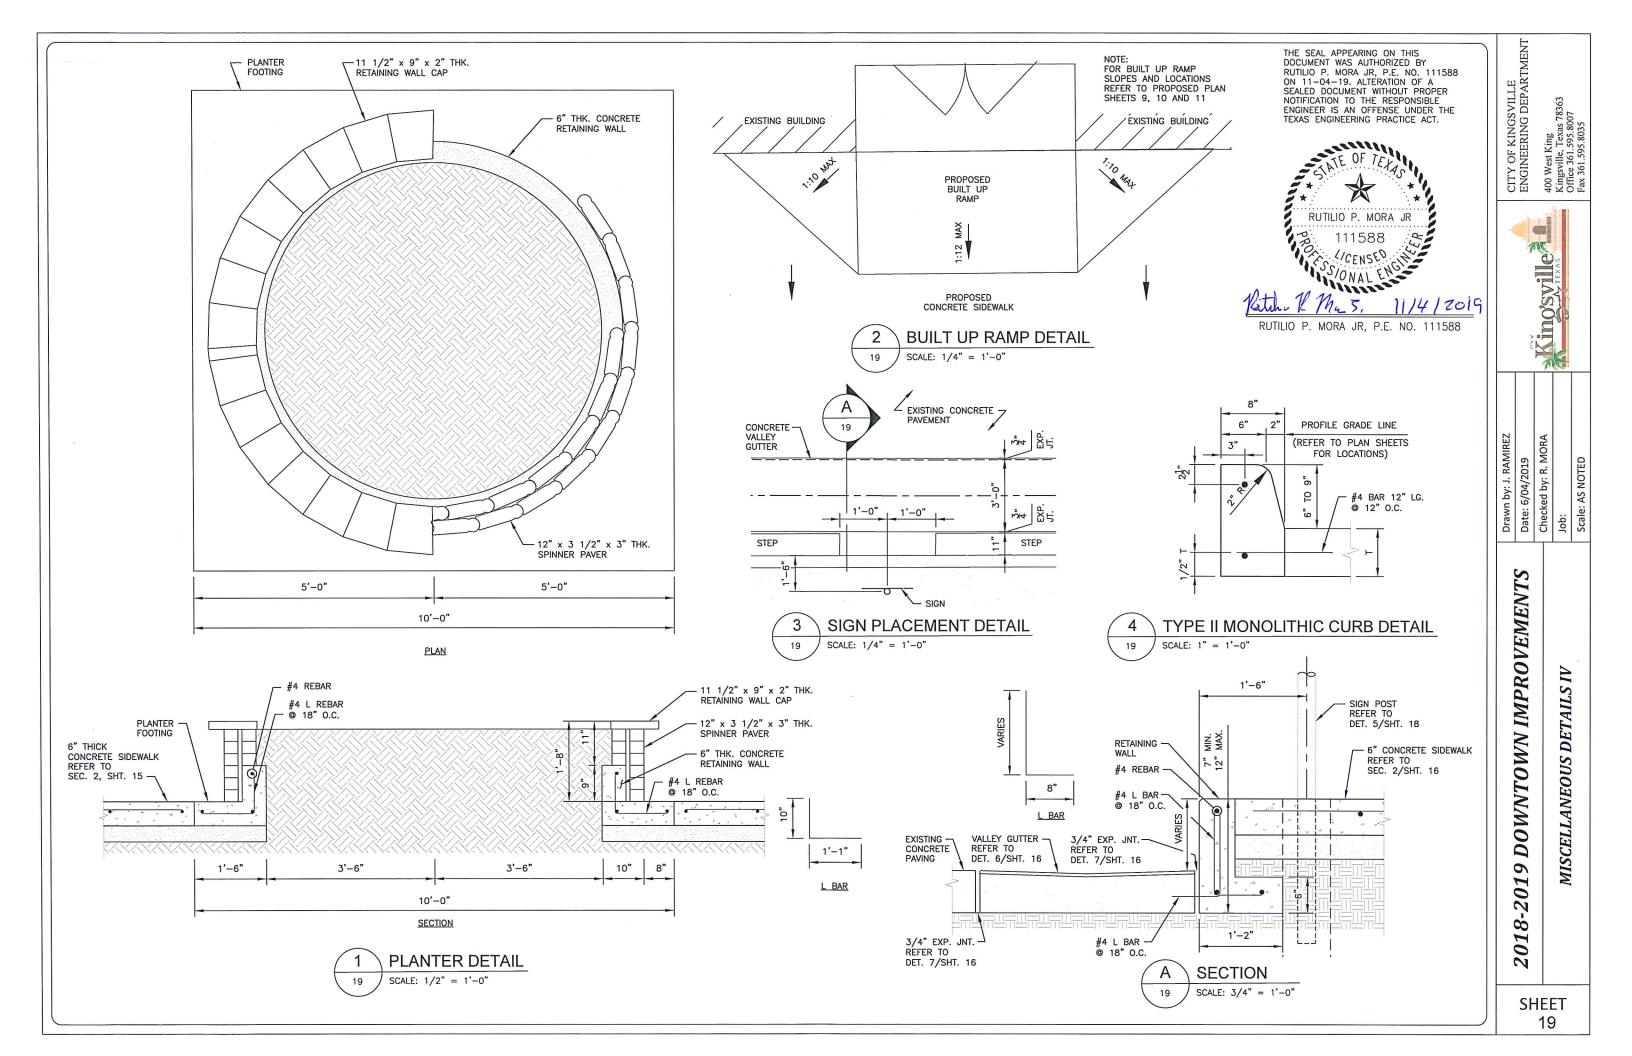
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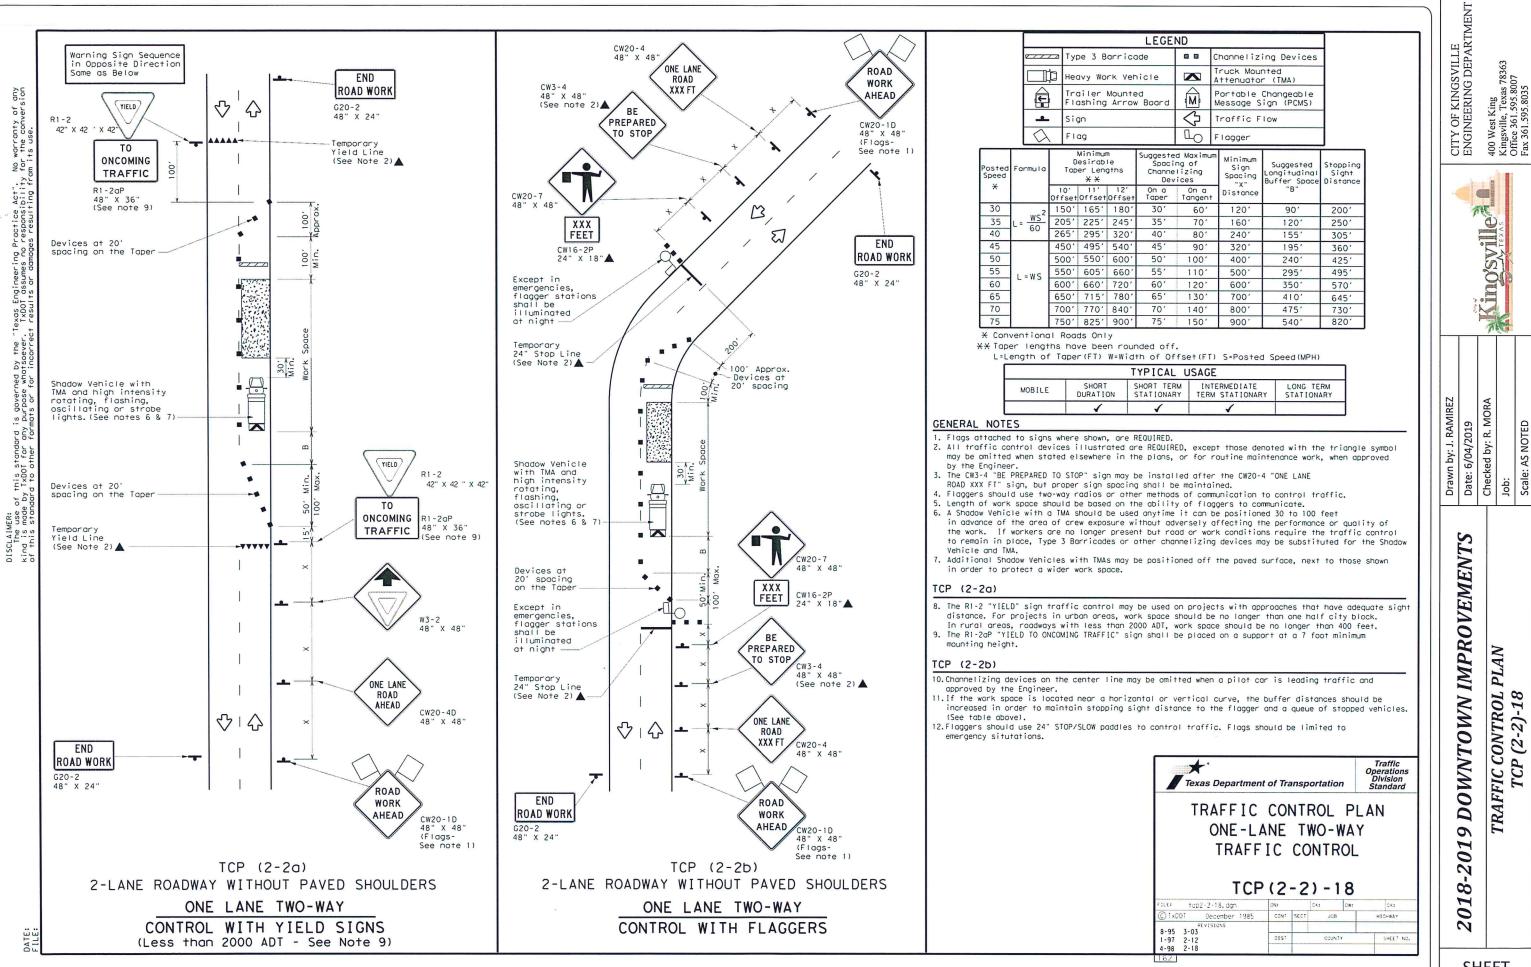
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MISCELLANEOUS DETAILS







TRAFFIC CONTROL PLAN TCP (2-2)-18