HISTORICAL DEVELOPMENT BOARD

Wednesday, November 30, 2022, 4:00 pm Special Meeting Helen Kleberg Groves Community Room, 1st Floor of City Hall 400 W King, Kingsville, Texas

BOARD MEMBERS

Maggie Salinas, Chairman
Daniel J. Burt
Jeri L.S Morey
Lucia Perez
David Thibodeaux
Chris Maher
Taulia Laureno

CITY STAFF

Kobby Agyekum Senior Planner/ Historic Preservation Officer

Herlinda Solis Administrative Assistant II

The following rules of conduct pertaining to public comments have been adopted by this Board:

- 1. Give your name and complete address.
- 2. No one may speak more than twice on the same item.
- 3. No one may speak more than five minutes at a time without permission from the Chairman.
- 4. No one may speak a second time on a question until every person who wants to speak has done so
- 5. All submissions of evidence, i.e. photos, drawings, will be retained by the Historical Development Board and will become a part of the permanent file.

When speaking at the podium, if necessary, adjust the microphone and clearly speak into the microphone.

- 1. CALL TO ORDER
- 2. ROLL CALL
- 3. APPROVAL OF MINUTES FROM PREVIOUS MEETING(s)- October 19, 2022
- 4. PUBLIC COMMENTS FOR ALL AGENDA & NON-AGENDA ITEMS (SEE MEETING RULES)
- 5. POSTPONEMENTS/ADJUSTMENTS TO THE AGENDA
- 6. AGENDA ITEMS

Item #1 Discuss and Consider Action to install 20 solar panels on the roof of residential building on ORIG TOWN, Block 4, Lots 1-3 also known as 231 West Santa Gertrudis Avenue, Kingsville, TX 78363

Item #2 Discuss and Consider Action to remove and replace siding, west side building from fence to porch, south side building entirety on residential parcel on ORIG TOWN, Block 67, Lots 1-12 also known as 223 South 6th Street, Kingsville, TX 78363

Item #3 Discuss and Consider Action to construct a driveway on residential parcel on ORIG TOWN, Block 19, Lots 20-26 also known as 308 West Lee Avenue, Kingsville, TX 78363

- STAFF REPORT: None
- MISCELLANEOUS Any topic may be discussed but no action taken at this time.
- ADJOURNMENT

PUBLIC NOTICE

It is the intention of the City of Kingsville to comply in all aspects with the Americans with Disabilities Act (ADA). If you plan on attending a meeting to participate or observe and need special assistance beyond what is routinely provided, the city will attempt to accommodate you in every reasonable manner. Please contact the City Secretary at 361-595-8002 at least two business days prior to the meeting to inform the City of your specific needs and to determine if accommodation is feasible.

I certify that this agenda was posted at least seventy-two (72) hours before the commencement of the Historical Development Board Meeting scheduled for Wednesday, November 30th, 2022 by 5:00 PM. on Wednesday November 23, 2022.

_S/ Kwabena Agyekum	
Kobby Agyekum, Senior Planner / Historic Preservation Officer	Posted @ <u>11:00AM</u>
This public notice was removed from the official posting board at the Kingsville City Hall on the following date and time:	On 11/23/22
By:	By Herlinda Solis_
Planning & Development Services	
City of Kingsville	

ITEM #1

CITY of KINGSVILLE **DOWNTOWN**



HISTORIC DEVELOPMENT BOARD

DATE:

November 4, 2021

TO:

Historic Development Board

FROM:

Kobby Agyekum (Senior Planner/Historical Preservation Officer)

SUBJECT:

Discuss and Consider Action to install 20 solar panels on the roof of residential

building on ORIG TOWN, Block 4, Lots 1-3 also known as 231 West Santa Gertrudis

Avenue, Kingsville, TX 78363

APPLICANT:

Louis A Gonzalez, Mr.

CONTRACTOR: 5 Star Solar LLC

REQUEST

Discuss and Consider Action to install 20 solar panels on the roof of residential building on ORIG TOWN, Block 4, Lots 1-3 also known as 231 West Santa Gertrudis Avenue, Kingsville, TX 78363

EXHIBITS

Application, 2020 Appraisal Roll, Kleberg County Appraisal District Information details, Data from Texas Historical Commission (Historic Resources Survey Form), Engineer's letter, Authorization letter, Drawings, and illustrations.

BACKGROUND & PERTINENT DATA

This is a 1945 one-story hip-roofed rectangular-plan residential building with hip=roof partial centered entry porch supported by fabricated metal posts over front stoop, replacement front door, replacement sash windows, horizontal vinyl siding, located within the Historic District. This property is considered contributing to the historic district with low priority for preservation.

STAFF REVIEW & RECOMMENDATION

Staff has reviewed the application and found same to be in conformity with sustainable development which forms the new ethos of the emerging Comprehensive Plan. Consequently, it is the recommendation of Staff to approve the installation of the 20 solar panels on the roof of residential building at 231 West Santa Gertrudis Avenue as there would be no adverse impact to the historic, cultural, or architectural nature of the district.

BOARD REVIEW

Scope of Historical Development Board

In general, Historical Development Board considers the following factors when making a recommendation concerning the issuing of a permit for the construction, reconstruction, alteration, restoration, relocation, demolition or razing of all or part of any building, structure or appurtenance within a historic district:

1) The effect of the proposed change upon the general historic, cultural and architectural nature of the district.

- 2) The appropriateness of exterior architectural features which can be seen from a public street, alley, road, highway or walkway.
- 3) The general design, arrangement, texture, material and color of the building, structure or appurtenances and the relation of such factors to similar features of buildings, structures or appurtenances in the district. The criterion shall not be the aesthetic appeal to the Board of the structure or the proposed remodeling, but rather its' conformity to the general character of the particular historic area involved.
- 4) Signs which are out of keeping with the character of the historic district in question shall not be permitted.
- 5) The value of the historic district as an area of unique interest and character shall not be impaired.

Standards of the Secretary of the Interior

- 1. A property shall be used for its historic purpose or be placed in a new use that requires minimal change to the defining characteristics of the building and its site and environment.
- 2. The historic character of a property shall be retained and preserved. The removal of historic materials or alteration of features and spaces that characterize a property shall be avoided.
- 3. Each property shall be recognized as a physical record of its time, place, and use. Changes that create a false sense of historical development, such as adding conjectural features or architectural elements from other buildings, shall not be undertaken.
- 4. Most properties change over time; those changes that have acquired historic significance in their own right shall be retained and preserved.
- 5. Distinctive features, finishes, and construction techniques or examples of craftsmanship that characterize a property shall be preserved.
- 6. Deteriorated historic features shall be repaired rather than replaced. Where the severity of deterioration requires replacement of a distinctive feature, the new feature shall match the old in design, color, texture, and other visual qualities and, where possible, materials. Replacement of missing features shall be substantiated by documentary, physical, or pictorial evidence.
- 7. Chemical or physical treatments, such as sandblasting, that cause damage to historic materials shall not be used. The surface cleaning of structures, if appropriate, shall be undertaken using the gentlest means possible.
- 8. Significant archeological resources affected by a project shall be protected and preserved. If such resources must be disturbed, mitigation measures shall be undertaken.
- 9. New additions, exterior alterations, or related new construction shall not destroy historic materials that characterize the property. The new work shall be differentiated from the old and shall be compatible with the massing, size, scale, and architectural features to protect the historic integrity of the property and its environment.
- 10. New additions and adjacent or related new construction shall be undertaken in such a manner that if removed in the future, the essential form and integrity of the historic property and its environment would be unimpaired.

SIGNATURES

Kobby Agyekum Senior Planner/HPO

Historical Development Board Review Application

Applicant: Luis A. Gonzalez
Address: 612 North 4th Street, Kingsville Texas 78363
Contact: Cell: 361-522-8184 Home: N/A
Email: Igonzalez6000@outlook.com
Property Owner: Maria D. Gonzalez
Address: 231 West Santa Gertrudis
Contact: Cell: 361-675-0529 Home: N/A
Property Location and Description: The main property is at the corner of 4th and Santa Gertrudis. Which is a yellow single family home house. White house in the back is an additional structure on the main property with a different address.
Description of Work: Solar Panel Installation will be on the additional structure which is the white
house in the back on the main property.
Contractor: 5 Star Solar LLC
Contact: Cell: (512)784-7161 Home:
Email: Shawnshiller@5-starsolar.com
Documents Required:
Sketch, Drawing, Plans, Site Plans, Mock-ups Sketch, Drawing, Plans, Site Plans, Mock-ups Sketch, Drawing, Plans, Site Plans, Mock-ups
Photographs (Historic, Current, Surrounding Structures) Materials List or Samples
4. Proof of Ownership
Letter of Representation and Work Approval from Property Owner (If Applicable)
I certify that this information and the additional information submitted to the Planning Department is correct and that the work will be completed as described, as approved by the Historical Development Board and in accordance with applicable codes. (Applicant) Print Name: Luis A. Gonzalez
Signature:

Total Tax Rate:

3.194259

Taxes w/Current Exemptions: Taxes w/o Exemptions: \$527.24 \$1,698.71

Improvement / Building

Improvement #1: RESIDENTIAL State Code: A1 Living Area: 1422.0 sqft Value: \$45,680

Type	Description	Class CD	Exterior Wall	Year Built	SQFT
MA	MAIN AREA	FF3	EW3	1945	1422.0
OPFA	OPEN PORCH FRAME AVERAGE	*		1945	70.0
OPFA	OPEN PORCH FRAME AVERAGE	*		1945	10.0
STPP	STORAGE (CONSIDERED PP)	NV		1945	98.0

Land

#	Type	Description	Acres	Sqft	Eff Front	Eff Depth	Market Value	Prod. Value	-
1	A1	A1	0.2410	10500.00	75.00	140.00	\$7,500	\$0	į.

Roll Value History

Year	Improvements	Land Market	Ag Valuation	Appraised	HS Cap	Assessed
2023	N/A	N/A	N/A	N/A	N/A	N/A
2022	\$45,680	\$7,500	0	53,180	\$9,037	\$44,143
2021	\$32,630	\$7,500	0	40,130	\$0	\$40,130
2020	\$31,370	\$7,500	0	38,870	\$0	\$38,870
2019	\$31,370	\$7,500	0	38,870	\$0	\$38,870
2018	\$32,250	\$7,500	0	39,750	\$0	\$39,750
2017	\$32,250	\$7,500	0	39,750	\$0	\$39,750
2016	\$32,250	\$7,500	0	39,750	\$0	\$39,750
2015	\$32,210	\$7,500	0	39,710	\$0	\$39,710
2014	\$32,210	\$7,500	0	39,710	\$0	\$39,710
2013	\$32,210	\$7,500	0	39,710	\$0	\$39,710
2012	\$32,620	\$7,500	0	40,120	\$0	\$40,120
2011	\$32,620	\$7,500	0	40,120	\$0	\$40,120
2010	\$32,620	\$7,500	0	40,120	\$0	\$40,120
2009	\$32,620	\$7,500	0	40,120	\$0	\$40,120

Deed History - (Last 3 Deed Transactions)

#	Deed Date	Туре	Description	Grantor	Grantee	Volume	Page	Deed Number
1	11/14/2013	DEATH	DEATH - ADD EST TO OWNERSHIP	GONZALEZ MARIA D	GONZALEZ MARIA D			
2	6/8/2004	WDVL	WARRANTY DEED W/VENDOR'S LEIN	CAMACHO ELISEO	GONZALEZ MARIA D	284	819	
3		ОТ	Other	UNKNOWN	CAMACHO ELISEO			

Tax Due

Property Tax Information as of 11/03/2022

Amount Due if Paid on:

Year	Taxing Jurisdiction	Taxable Value	Base Tax	Base Taxes Paid	Base Tax Due	Discount / Penalty & Interest	Attorney Fees	Amount Due	- American
	Julisalcuon	value	IdA	raiu	Due	millerest	rees	Due	- 3

EDVIC HISTORICA		
TEXAS HISTORICA	L COMMISSION	131
Project #: 00009 Historic Resource	es Survey Form	Local Id: 0001-10671
County: Kleburg		City: Kingsville
Address No: 231 Street Name: West Santa Ge	rtrudis Avenue	
SECTION 1		
Basic Inventory Information		
Current Name:		
Historic Name:		
Owner Information Name: Gonzalez Maria D.	Status:	·
Address: 231 West Santa Gertrudis Av City: Kingsville	State: TX	Zip: 78363
Geographic Location Latitude: 27.522502	Longitude: -97.870	548
Legal Description (Lot\Block): ORIG TOWN, BLOCK 4, LOT 1-3		
Addition/Subdivision:		Year:
Property Type Building		
Current Designations: NR District Is property contributing	ng?	
□ NHL □ NR □ RTHL □ OTHM □ HTC □ SAL	☐ Local ☐ Other	
Architect: Buil	der	
Contruction Date: c. 1920 Sou	rce Tax Appraiser	
Function		
Current: DOMESTIC-Single Dwelling		
Historic: DOMESTIC-Single Dwelling		

Recorded By: Florence Ruiz

Date Recorded:

6/18/2013



		7	TEXAS HISTORICA	AL COMMISSIO	N 131	
Project #:	00009		Historic Resource	es Survey Form	Local Id: 0001-10671	
County:	Kleburg				City: Kingsville	
Address No:	231		Street Name: West Santa	Gertrudis Avenue		
SECTION 2	2					
	ral Descriptio					
One-story hip- metal posts or	-roofed rectanguver front stoop,	ılar-plan re replaceme	esidential building with hip-ro ent front door, replacement sa	ofed partial-width centered sh windows, and vinyl sidi	d entry porch supported by fabricated ng.	i
✓ Additions,	, modifcations	Explain:	replacement materials			
☐ Relocated	Г	Explain:				
Stylistic Inf	luence					
No Style						
Structural I						
Roof Form	1					
Hipped						
Roof Mate	rials					
Composition	Shingles	ĸ				
Wall Mater	ials		p.			
Vinyl						
Windows						
Metal sash						
Doors (Pri	mary Entrance	е				
Composition	Shingles					
Plan						
Rectangular						
Chimneys						
Porches/C	anopies					
FORM	Hipped Roof					
SUPPORT	Fabricated met	al				
MATERIAL						
ANCILLARY B	UILDINGS:	~				
Garage:		В	arn:	Shed:	Other:	
Landscape	Features					

		TE	XAS HIST	ORICAL COM	MISSIOI	N		131
Project #:	00009	H	listoric Re	esources Surve	ev Form	Local Id:	0001-10671	
County:	Kleburg						Kingsville	
Address No:		A STATE OF THE PARTY OF THE PAR		est Santa Gertrudis Aver	nue			
SECTION 3		al Information	n					
Associated H Planning/Deve		itext						
Applicable N	National Reg	jister (NR) Cri	iteria:					
✓ A	Associated	with events tha	at have made a s	significant contribution t	o the broad	pattern of our hist	tory	
□в			of persons signific					
□ c	Embodies the distinctive characteristics of a type, period or method of construction or represents the work of a master, or possesses high artistic value, or represents a significant and distinguishable entity whose components lack individual distinctions							
□ D	Has yielded	l, or is likely to	yield, informatio	n important in prehistor	y of history			
Areas of Sign								
Community De	•							
Periods of Si	gnificance:							
Levels of Sig	nificance:	☐ National	☐ State	✓ Local				
Integrity:	Location	Design	\square Materials	☐ Workmanship	Setting	☐ Feeling	☐ Association	,
Integrity Not lacks integrity								
Individually I	Eligible? No		Within Potent	ial NR District?: Yes		Is Property Co	ontributing?:	
Priority:	Medium	Expla	ain:					
Other Inform								
		vailable for th	nis resource?	No	Type	☐ HABS ☐ Su	rvey Other	r
Documentati	on Details:							



PROPERTY EASEMENT VERIFIED: YES/NO

AICUZ/CCLUA** DEED NOTIFICATION: YES/NO

DATE

CITY OF KINGSVILLE

Planning Department

Building Permit Application
Phone No: (361) 595-8019
Submit the completed form and an Inspector will be assigned to review your application and property before starting the following job.

10/19/22	PERMIT# :		APPROVED BY:
JOB ADDRESS:	4th St Vian	^1/ · · ·	1/ 2
OWNER'S NAME: LAST:	TITOTI, KINOPU	HE TX	78363
(10020	yez	FIRST:	nana M:
MAILING ADDRESS:	in St.	PHON	ENO: nC2/
CITY: Vina C. (1)	STATE:	1 (3)	ZIP CODE:
CONTRACTOR:			18363
5.St	ar Solar ilc		EM28471(a)
DESCRIPTION OF WORK:			□ Remodel
Colon 20 1 1		uare Feet	1010
Sour rane In	stallation		
VALUATION OF WORK: \$	48,380-	PERMIT	FEE: \$
* Contra	actor must be regist	ered with	the City of Kingsville.
1	M	TICE	
CONTRACTORS ARE RESPONSIB	ED FOR, ELECTRICAL, PLU LE FOR DISPOSING OF THE	MBING, HEA	TING, VENTILATING OR AIR-CONDITIONING; ALL RIS AT THE SANITARY LANDFILL ON CR 2130.
THIS PERMIT BECOMES NULL AN	D VOID IF WORK OR CONS	TRUCTION	RIS AT THE SANITARY LANDFILL ON CR 2130. AUTHORIZED IS NOT COMMENCED WITHIN SIX
AFTER WORK IS COMMENCED.	OK WORK IS SUSPENDED	OR ABANDO	AUTHORIZED IS NOT COMMENCED WITHIN SIX NED FOR A PERIOD OF 6 MONTHS AT ANY TIME
The state of the s	- mlx	3/12	
SIGNATUR	DATE	1100	
0-6-			
WHICHTHIS PERMIT IS BEING ISS	LY: I HEREBY CERTIFY THA	T I OWN AN	D AM NOW LIVING AT THE DWELLING FOR PERMORMED BY ME OR A MEMBER OF MY
		OSES OF THI	S APPLICATION, MY IMMEDIATE FAMILY IS
LIMITED TO MY PARENT, CHILD	OR CHILD'S SPOUSE. INITIAL HE		TABLE 13
	FOR OFFI	CE USE OI	NLY
CURRENT ZONING FOR LOCATIO	N:	IS ZONING	APPROPRIATE FOR USE REQUIRED: YES/NO
SETBACK REQUIREMENTS VERIFIE	.D: YES/NO	ARE SETBA	CK REQUIREMENTS MET: YES/NO
IS THE PROPERTY IN THE AICUZ/	CCLUA **. VECAIO	Done -	
15 THE PROPERTY IN THE AICUZ/	CCLUA"": YES/NO	DOES IT CO	OMPLY WITH THE AICUZ/CCLUA**: YES/NO

DIMENTION OF EASEMENT:

** CONTROLLED COMPATIBLE LAND USE AREA (JAZB)

PHOTOVO INT SYSTEM

20 MODULES-ROOF MOUNTED - 8.000 kWDC, 6.500 kWAC 612 N 4TH ST, KINGSVILLE, TX 78363, USA

SYSTEM SUMMARY:

(N) 20- Q ECLIS Q.PEAK DUO BLK ML-G10+ (400W) MODULES

(N) 20- Q ENPHASE ENERGY IQ8M-72-2-US MICRO-INVERTERS [240V]

(N) JUNCTION BOX

(N) JUNCTION BOX

(N) 200A MAIN SERVICE PANEL WITH (N) 200A MAIN BREAKER

(N) 60A FUSED VISIBLE LOCKABLE L'ABELED AC DISCONNECT [240V]

(N) ENPHASE IQ COMBINER BOX 4 [240V]

INTERCONNECTION METHOD: BACKFEED BREAKER

MSP UPGRADE: YES EXISTING MSP INFORMATION

(E) 100A MAIN SERVICE PANEL WITH (E) 100A MAIN BREAKER

DESIGN CRITERIA:

ROOF TYPE: - COMP SHINGLE
NUMBER OF LAYERS: - 01
ROOF FRAME: - 2"X4" RAFTERS @24" O.C. STORY: - ONE STORY

SNOW LOAD : - 0 PSF WIND SPEED :- 136 MPH WIND EXPOSURE:- C RISK CATEGORY:- II

GOVERNING CODES:

2018 INTERNATIONAL SWIMMING POOL AND SPA CODE 2018 INTERNATIONAL RESIDENTIAL BUILDING CODE 2018 INTERNATIONAL PROPERTY MAINTENANCE CODE 2018 INTERNATIONAL ENERGY CONSERVATION CODE 2018 INTERNATIONAL FUEL GAS COD 2018 INTERNATIONAL BUILDING CODE
2018 INTERNATIONAL EXISTING BUILDING CODE
2018 INTERNATIONAL MECHANICAL CODE 2017 NATIONAL ELECTRICAL CODE 2018 INTERNATIONAL PLUMBING CODE

SITE PLAN WITH ROOF PLAN ROOF PLAN WITH MODULES ATTACHMENT DETAILS ATTACHMENT DETAILS

ELECTRICAL LINE DIAGRAM WITH **ALCULATION**

UTILITY ESID NO: 10032789480829830 UTILITY METER NO: 142 422 462

PV-3 PV-3.1 COVER SHEET

QUIPMENT SPEC SHEETS

CONSTRUCTION NOTE:

A LADDER SHALL BE IN PLACE FOR INSPECTION

INVERTER LOCATION CONSISTING OF A UI. USTED 8 FT GROUND ROD WITH ACORN CLAMP. GROUNDING ELECTRODE CONDUCTORS SHALL BY NOL ESS THAN #8 AWG AND NO GREATER THAN #8 AWG COPPER AND BONDED TO THE EXISTING GROUNDING ELECTRODE TO PROVIDE OR A THE PV MODILES ARE CONSIDERED NON-COMBUSTIBLE AND THIS SYSTEM IS A UTILITY GRID INTERACTIVE SYSTEM IS A UTILITY GRID INTERACTIVE SYSTEM A GROUNDING ELECTRODE SYSTEM IN ACCORDANCE WITH NEC 650-47 AND 250-50 THROUGH 60 250-166 SHALL BE PROVIDED PER NEC. ROUNDING ELECTRODE SYSTEM OF EXISTING BUILDING MAY BE USED ND BONDED TO AT THE SERVICE ENTRANCE. IF EXISTING SYSTEM IS VACCESSIBLE, OR INADEQUATE, OR IS ONLY METALLIC WATER PIPING,

EACH MODULE WILL BE GROUNDED USING THE SUPPLIED GROUNDING POINTS IDENTIFIED BY THE MANUFACTURER.

EXPOSED NON-CURRENT CARRYING METAL PARTS OF MODULE FRAMES, EQUIPMENT, AND CONDUCTOR ENCLOSURES SHALL BE GROUNDED IN ACCORDANCE WITH 250.134 OR 250.138(A) REGARDLESS OF VOLTAGE.

PROPER ACCESS AND WORKING CLEARANCE AROUND EXISTING AND PROPOSED ELECTRICAL EQUIPMENT WILL BE PROVIDED

HEIGHT OF INTEGRATED AC/DC DISCONNECT SHALL NOT EXCEED 6' 7"

ALL SIGNAGE WILL BE INSTALLED AS REQUIRED BY AND 2017 NEC.

THE GROUNDING ELECTRODE CONDUCTOR SHALL BE PROTECTED FROM PHYSICAL DAMAGE BETWEEN THE GROUNDING ELECTRODE AND THE ANEL (OR INVERTER) IF SMALLER THAN #5 AWG COPPER WIRE PER NEC 250-64B. THE GROUNDING ELECTRODE CONDUCTOR WILL BE **EXTERIOR CONDUIT SHALL BE PAINTED TO MATCH ADJACENT**

MAIN CIRCUIT LÓCATIÓN. NEC 690.6(B)(Y)
SITE CONDITIONS SHALL PREVAIL IF NO SCALE IS GIVEN. DRAWINGS
SITE CONDITIONS SHALL PREVAIL FINDENSIONS SHALL BE VERIFIED
ARE NOT NECESSARILY TO SCALE. ALL DIMENSIONS SHALL BE VERIFIED
BY SUBCONTRACTOR UPON COMMENCEMENT OF CONSTRUCTION. HE PV CONNECTION IN THE PANEL BOARD SHALL BE POSITIONED AT HE OPPOSITE (LOAD) END FROM THE INPUT FEEDER LOCATION OR

ALL EQUIPMENT TO BE LISTED BY UL OR OTHER NRTL, AND LABELED FOR

- ITS APPLICATION.
- ALL CONDUCTORS SHALL BE COPPER, RATED FOR 600 V AND 90 & 75
 DEGREE C WET ENVIRONMENT.
 WIRING, CONDUIT, AND RACEWAYS MOUNTED ON ROOFTOPS SHALL BE
 ROUTED DIRECTLY TO, AND LOCATED AS CLOSE AS POSSIBLE TO THE
- NEAREST RIDGE, HIP, OR VALLEY.
 WORKING CLEARANCES AROUND ALL NEW AND EXISTING ELECTRICAL
 EQUIPMENT SHALL COMPLY WITH CEC 110.26.
- DRAWINGS INDICATE THE GENERAL ARRANGEMENT OF SYSTEMS. CONTRACTOR SHALL FURNISH ALL NECESSARY OUTLETS, SUPPORTS, FITTINGS AND ACCESSORIES TO FULFILL APPLICABLE CODES AND
- WHERE SIZES OF JUNCTION BOXES, RACEWAYS, AND CONDUITS ARE NOT SPECIFIED, THE CONTRACTOR SHALL SIZE THEM ACCORDINGLY.
- ALL WIRE TERMINATIONS SHALL BE APPROPRIATELY LABELED AND
- MODULE GROUNDING CLIPS TO BE INSTALLED BETWEEN MODULE FRAME AND MODULE SUPPORT RAIL, PER THE GROUNDING CLIP

VICINITY MAP

SHEET NUMBER

PV-0

11" X 17"


ANSI B


SHEET SIZE

COVER SHEET

SHEET NAME

MANUFACTURER'S INSTRUCTION.
MODILE SUPPORT PAIL TO BE BONDED TO CONTINUOUS COPPER E.G.C.
MA WEEB LUG OR ILSCO GEL-ABBT LAY-IN LUG.
THE POLARITY OF THE GROUNDED CONDUCTORS IS NEGATIVE

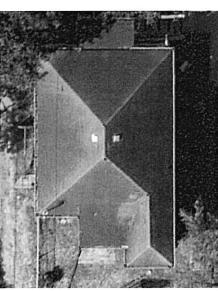

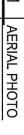





MARIA GONZALEZ 612 N 4TH ST, KINGSVILLE,TX 78363 USA


UTILITY: AEP


NITIAL RELEASE DESCRIPTION **DEL MAR, CA 92014, USA** FIRM REGISTRATION NO F-21435 powur Exp. 9/30/2023 9/24/2022 132223 VERSION 09/01/2022 DATE F

AHJ: CITY OF KINGSVILLE

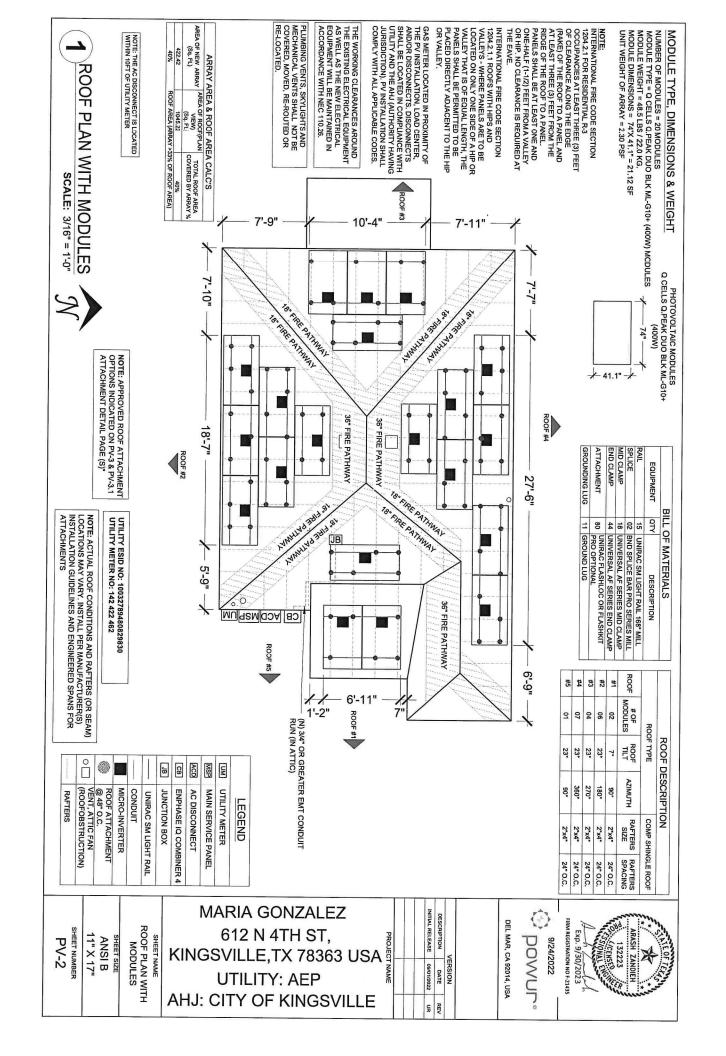


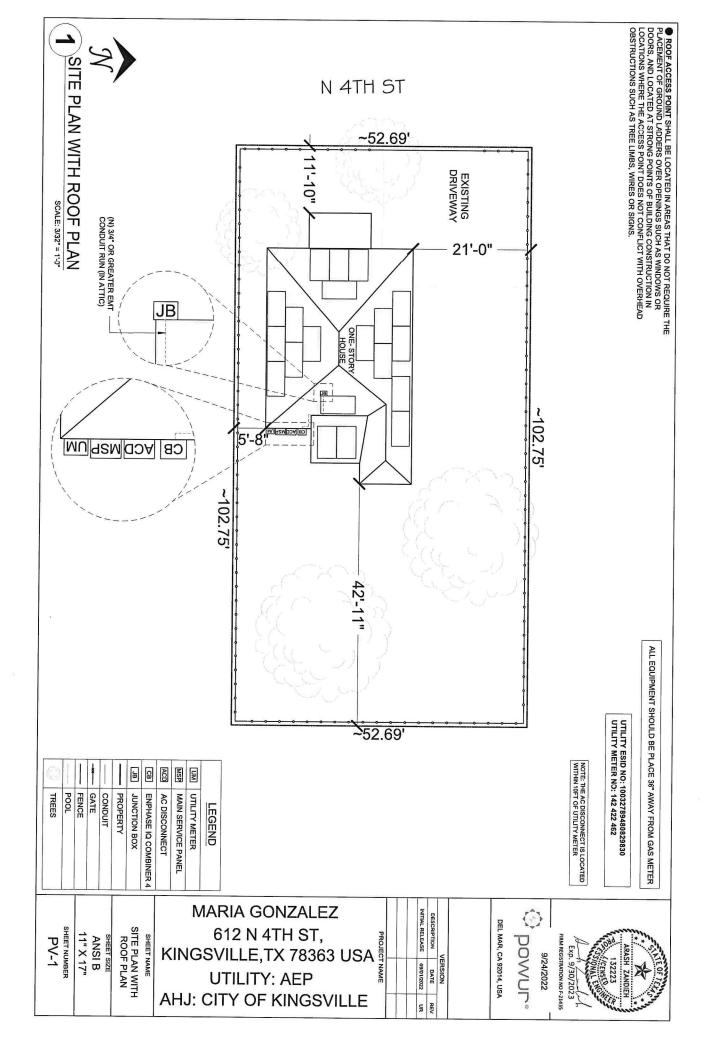


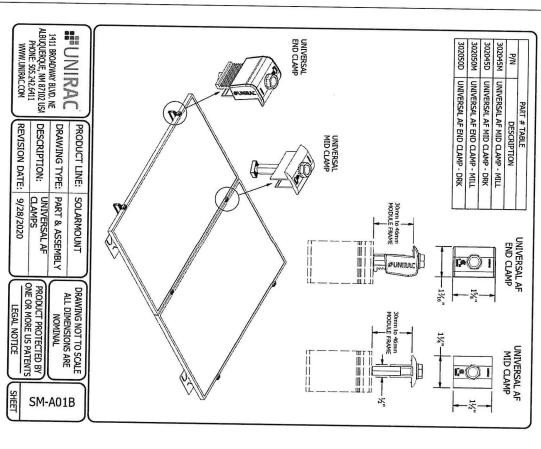

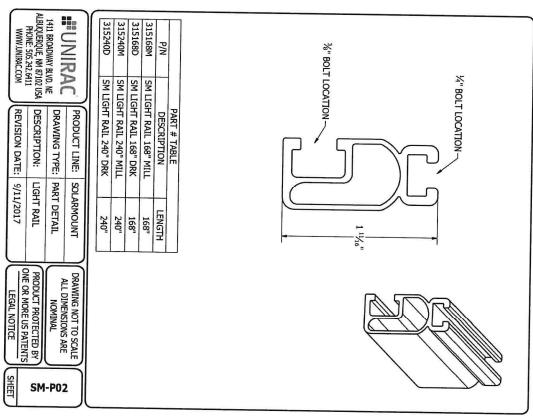

				MARIA GONZALEZ	DESC		
	PV	ANS	SPEC	612 N 4TH ST,	SCRIPTION AL RELEASE	DEL MAR.	
	-9 IUMBER	SI B	SH NA	KINGSVILLE,TX 78363 USA	VERS		
	"		EETS	UTILITY: AEP	ATE 01/2022		
L				AHJ: CITY OF KINGSVILLE	UR REV	>) •	

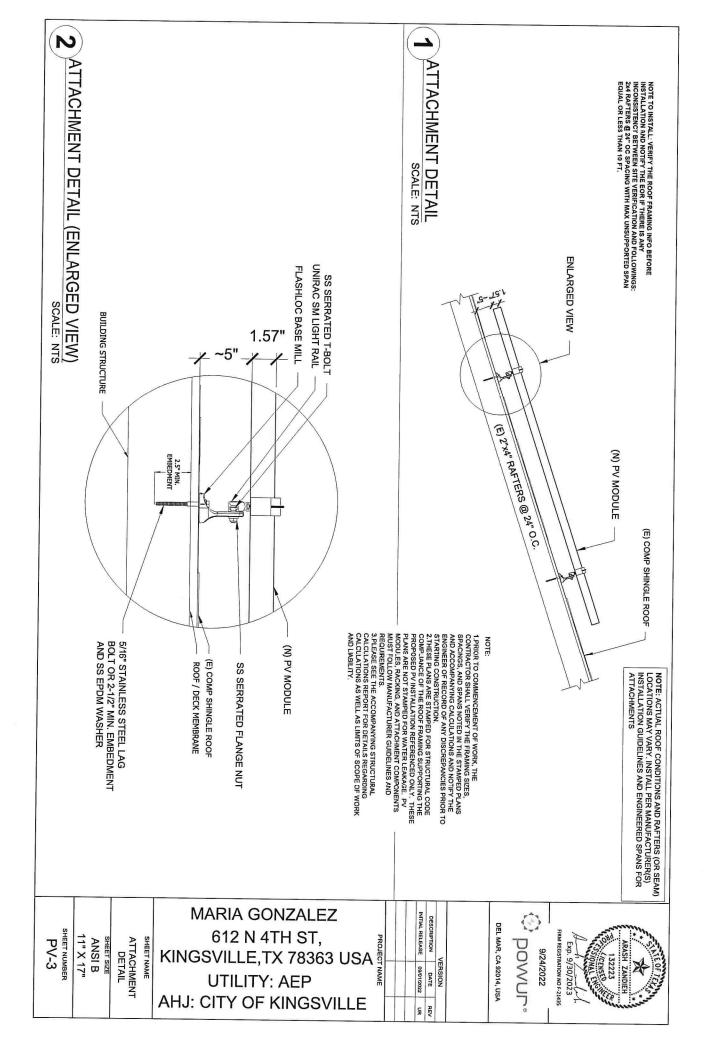

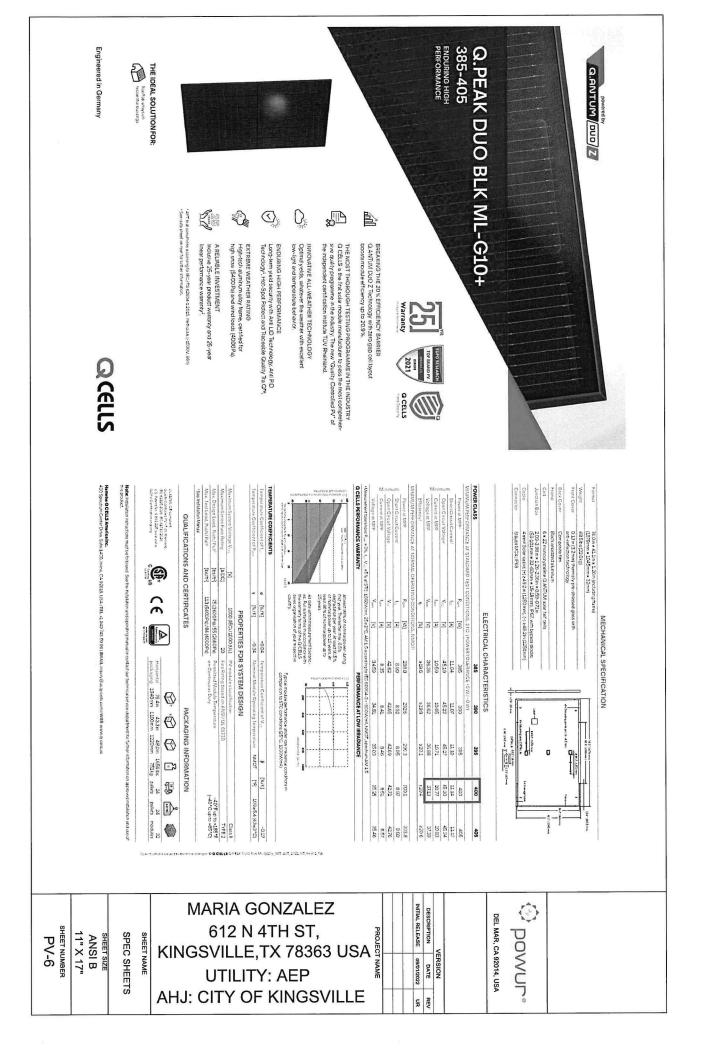

ELECTRIC SHOCK HAZARD WARNING

LABEL LOCATION:
AC & DC DISCONNECT AND SUB PANEL
(PER CODE: NEC 690.13(B)) SIDES MAY BE ENERGIZED IN THE

A WARNING DUAL POWER SOURCE ECOND SOURCE IS PHOTOVOLTAIC SYSTEM

LABEL LOCATION:
MAIN SERVICE PANEL & NET METER
(PER CODE: NEC 705.12(D)(3), NEC
705.12(B)(3-4) & NEC 690.59)

LABEL LOCATION:
AC DISCONNECT & INVERTER
(PER CODE: NEC690.54) **△ WARNING**

LABEL LOCATION:
SERVICE PANEL IF SUM OF BREAKERS EXCEEDS
PANEL RATING
(PER CODE: NEC 705.12 (B)(2)(3)(B) DO NOT RELOCATE THIS OVERCURRENT DEVICE

PHOTOVOLTAIC SYSTEM AC DISCONNECT AC NOMINAL OPERATING VOLTAGE 240 VOLTS

SOLAR PV SYSTEM EQUIPPED

WARNING:PHOTOVOLTAIC POWER SOURCE

SHUTDOWN SWITCH
TO THE "OFF" POSITION
TO SHUTDOWN PV SYSTEM AND REDUCE SHOCK HAZARD IN WITH RAPID SHUTDOWN TURN RAPID ARRAY SOLAR ELECTRI

LABEL LOCATION:
AC DISCONNECT, DC DISCONNECT, POINT OF INTERCONNECTION
(PER CODE: 605.11.3.1(1) & 690.56(C)(1)(a))

AC DISCONNECT NEC 690.13(B)

AC DISCONNECT

PHOTOVOLTAIC

LABEL LOCATION:
CONDUIT, COMBINER BOX
(PER CODE: NEC 690.31(G)(3) MAIN PHOTOVOLTAIC SYSTEM DISCONNECT

ABEL LOCATION:

(PER CODE: NEC 690.56(C)(3) RAPID SHUTDOWN ABEL LOCATION:

RAPID SHUTDOWN SWITCH FOR SOLAR PV SYSTEM

(PER CODE: NEC 690.13 (F), NEC 705.12(B)(3-4) & NEC 690.59)

MSP

PHOTOVOLTAIC SYSTEM CIRCUIT IS BACKFED

A CAUTION

MAIN SERVICE DISCONNECT / UTILITY METER (PER CODE: NEC 690.13(B))

INITIAL RELEASE 09/01/2022 PROJECT NAME VERSION

MARIA GONZALEZ

SHEET NUMBER 11" X 17" PV-5 ANSI B SHEET SIZE

SHEET NAME

WARNING LABELS

612 N 4TH ST, KINGSVILLE, TX 78363 USA **UTILITY: AEP**

AHJ: CITY OF KINGSVILLE

DEL MAR, CA 92014, USA DOWUL

								LCULATION SCALE: NTS	/ITH CA	ELECTRICAL LINE DIAGRAM WITH CALCULATION	INE DIA	RICAL L	ELECTI	3
NWHT	10 AWG	27.00	1.35	20	44.00	1.0	0.88	50	75°C	NWHT	8 AWG	ω	3/4" EMT) ი
THWN-2	10 AWG	13.50	1.35	10	21.84	0.80	0.91	30 OR 40	90°C	NM-B CABLES WHERE RUN INDOOR	12 AWG	4/2	3/4" EMT	В
BARE CU	06 AWG	13.50	1.35	10	27.30	1.0	0.91	30	90°C	Q Cable	12 AWG	2	OPEN AIR	Þ
GROUND WIRE TYPE	GROUND SIZE V	DESIGN CURRENT (A)	NOC (A)	INVERTER QTY	DERATED AMPACITY (A)	CONDUIT FILL DERATE	TEMP. DERATE	WIRE AMPACITY (A)	TEMP. RATING	WIRE TYPE	WIRE	WIRE QTY	CONDUIT	WIRE TAG
NOTE: THE AC DISCONNECT IS LOCATED WITHIN 10FT OF UTILITY METER	N 10FT OF UTILITY		ER THAN 6AWG D IN A CONDUIT RED PROTECTIV .64)	CONDUCTORS SMALLER THAN 6AWG SHALL BE PROTECTED IN A CONDUIT, RACEWAY, OR ARMORED PROTECTIVE SHEATHING (NEC 250.64)		STED AS SUNLI C1, 310.8 D)	ANY CONDUCTORS EXPOSED TO SUNLIGHT SHALL BE LISTED AS SUNLIGHT RESISTANT. (NEC 300.6 C1, 310.8 D)	NT C	THE EXISTING ELECTRICAL EQUIPMENT THE EXISTING ELECTRICAL EQUIPMENT WILL BE MAINTAINED IN ACCORDANCE WITH NEC 110.28.	ACCORDANCE V	UIT: HALL BE EMT R UNLESS	NOTE ON CONDUIT: ALL CONDUIT SHALL BE EMT 3/4" IN DIAMETER UNLESS OTHERWISE STATED		
	EXISTING GROUNDING SYSTEM				<u>Ω</u>	5			₩	D				
<i>IaP</i> PV ER	(N) 4DA/2P PV BREAKER	40A/ZP		Z	N N N N N N N N N N N N N N N N N N N		EWAY	M*) IQ-GATEWAY) 6 13		RTERS	(20) ENPHASE ENERGY IOBM-72-2-US MICRO-INVERTERS (240V) (LOCATED UNDER EACH PANEL) BRANCH TERMINATOR Q-TERM FOR IQ SERIES (TYP.)	(20) ENPHA: IQ8M-72-2-U (240V) (LOCATED U H TERMINATOR SERIES (TYP.)	BRANC FOR IQ
(9) MAIN SERVICE PANEL, 2000, RATED, 120/20P, (9) MAIN BREAKER 2001/2P, 240V	(N) MAIN SERVCE 200A RA: 120/240V (N) NAII 200A/ZF	200A		DANC DANC DANC DANC DANC DANC DANC DANC	NOAC DISCONNECT 6AA NON-FUSED VISBLE LABELED DISCONNECT, 240 VAC		1/5		(N) JUNCTION BOX	3				
		8-8					2/150					N BRANCH #2	NVERTERS	10 MICRO-I
	OH, S. F.	OTILITY METER 1-PHASE, 3-W. 120V/Z40V, 60HZ ER TOTAL	AC DISCONNECT SHALL BE LOCATED MITHIN 10' OF UTILITY METER	AC DISCONI WITHIN			10 1740VI	(N) ENPHASE IQ						
	Ā	ві-рікестіої						120% 240A	BUSS RATING x 120% 200A x 120% = 240A	2 8		BRANCH #1	10 MICRO-INVERTERS IN BRANCH #1	10 MICRO
1.35A	240 VAC	1-72-2-US 20	ENTHASE ENERGY (Q8M-72-2-US)	ENPHAS				R BACKFEED	UTILITY FEED + SOLAR BACKFEED 200A + 40A = 240A	חזורוגא		O.SOU AVVAC	STSTEM SIZE: ZO X SZSW - G.SOU NYWAG	O O I EM OIL
NOMIN	QUANTITY NOMINAL OUTPUT VOLTAGE	DEL # QUANTITY NOMINAL OU VOLTAG	MANUFACTURER / MODEL #	MANUI				TION 12(B)(2)(3)(b)	INTERCONNECTION 120% RULE - NEC 705.12(B)(2)(3)(b)	120% RL		8.000 kWDC	SYSTEM SIZE:- 20 x 400W = 8.000 kWDC	SYSTEM SI
COMPLY WITH ALL APPLICABLE CODES.	COMPLY WITH A		JN TO INVERTE	ATTIC RU		90°	N ATTIC	36.	ل ا	W x 1.57" D	74" [MODULE DIMENSION	MODULE
THE PV INSTALLATION, LOAD CENTER, ANDIOR DISCONNECTS, DISCONNECTS SHALL BE LOCATED IN COMPLIANCE WITH UTILITY AND THE AHJ (AUTHORITY HAVING	THE PV INSTALL AND/OR DISCON SHALL BE LOCA UTILITY AND THE		WITHIN STEEL FROM MISH WIRE RATED AND AMPACITY CALCULATED @ 90°C FOR ROOFTOP INSTALLATION AND		CONDUCTOR RE TEMPERATURE RATE (OFF	CONDUCTOR TEMPERATURE RATE (ON	CONDUIT	ORD AMBIENT TEMP (HIGH TEMP 2%)	#OF MODULES RECORD LOW TEMP	TEMPERATURE COEFFICIENT MO OF Voc -0.27%/°C	VOC ISC 45.30 11.14	VMP IMP 37.13 10.77	MANUFACTURER / MODEL # Q CELLS Q.PEAK DUO BLK MI_G10+ MODEL	MANUFACTU Q CELLS Q.F
CATED IN PROXIMITY OF	GAS METER LOC		MITUIN & FEET FROM MED	ROOM	ONO	OFECIFICATIO	AMBIENT TEMPERIORE SPECIFICATIONS	AMBIENT			SOLVIN MODOLE OF FOIL ICALIONS	200000		



Descriptive Report and Test Results

MASTER CONTRACT: 266909 REPORT: 70131735 PROJECT: 80128750

Edition 18:

June 8, 2022; Project 80128750 - Irvine Prepared By: Michael Hoffinagle Authorized By: Michael Hoffinagle

Contents:

Report pages reissued

Edition 17:

April 22, 2022: Project 80116723 - Irvine Prepared By: Michael Hoffnagle Authorized By: Michael Hoffnagle

Edition 1:

September 20, 2017: Project 70131735- Albuquerque Issued by Michael Hoffingle

SM SOLAR MOUNT

Electrical Bonding and Grounding Test Modules
The tisk telow is not exhaulter of compliant modules but shows those that have been evaluated and found to be electrically compatible with the SOLARMOUNT system.

System Certification | PAGI APPENDIX A C

DEL MAR, CA 92014, USA

POWUT

	Primar	Parasonic		Neo Sola Power Co.	Mitsubishi	Mission Solar Energy	Meyer Burger			TDNG		LG Electronics (cont.)	Manufacture
	SCALLAN GERER	VSHIBLINGA VSHIBLINGAD/OH VSHIBLINGA VSEA VSEA VSEA LISSAI SE, VSHIBLINGA VSEA VSEA LISSAI SE, VSHIBLINGA VSEA VSEA VSEA VSEA VSEA VSEA VSEA VSE	89195/919565195/51968 81195/119596929595911951	DOM Series	ME & ME SHE	NSE Mons, MSE Perc	Meyer Burger Black, Meyer Burger White	RoalBlack LR6-60HPB	Resident 184 40498	LR-720HP9 LR-60 LR-60\$YAFENIFILMYFEFE/PHQ LR-72	LR4-50(HPS/1P10	TOWNSTANS TOWNSTANS	Phodule Hodel / Series
		i k	2						Prism Solar	Phono Solar (core.)		Phono Sour	Manufacture
QPEAK DUO BLK G10+ /AC	QPEAK DUO BUK GIQ+	Obey Doo at 286. Obey Doo at 286.	GIEN DOD (BLK) GB(1)	QPEAK DUD (BLK)-67	Q.PEAX.DUD(BUX)-66+	Peak L-65, L-66, L-67, L-68(8FF)	Plus, Pro. Peak L-G2, L-G4, L-G5	Plut Pro. Prot. GS. Gs.	P71 Series	PScom4-24/T PScom4-24/TH PScom4-24/TH	PSxxxM1H-20VH	PSxxxXI-20V PSxxxXII-20UH PSxxxXII-20UH PSxxxXII-20UH	Module Model / Series
deas.	Shirt	Seaghin	SEG Solar	Carre	0				REC			Q falls (core)	Hanabetare
SUMMSULPS SIGMES PROSERVE	NU-SA & NU-SC Series	SEC ((BAVORE) CHACANA HY/ANG(CO)(E11) SEP ON MENO (CH SEP) AND	CELECTOR OF THE	2011 2000	ALL SAFON INSCREES	VECOTATIVA (STATE)	RECOXIPSM (Fact)	RECOGNIPSP972	RECORD RECORD P12	RECOUNT PLYELIN RECOUNT PLYELIN RECOUNT (BUCH) RECOUNT RECOUNTY	Ober Onoxi-0111/06.0	Obem dront-grouper Obem dront-grouper Group Obem dront-groupersons/groca	Hodale Hodel / Series

Unless otherwise noted, all modules listed above include all wattages and specific models within that cerics. Variable wattages are represented as 'xxxx'. Items in parenthesis are those bits may or may not be present in a compatible module's model. ID "Salates". The between the or more limits includes that other lower between the present in a module's model ID. "It is take politic must not larve any feature that implicit iteratives with the bonding devices that are integrated into the racking system. The rating is national work of the way feature that implicit iteratives with the bonding devices that are integrated into the racking system. Unless that any national water of the water than the models can be used to archive a class A fire system rating for steep slope applications. See Appendix A, page A.

Certificate of Compliance - Pages 1 to 6
Supplement to Certificate of Compliance - Pages 1 to 3
Description and Tests - Pages 1 to 23
Att Installation Manual SM- Pages 1 to 36
Att Schematics SM/ULA- Pages 1 to 36
Att Schematics SM/ULA- Pages 1 to 22
Att R.M.S. Installation Manual ULA- Pages 1 to 22
Att R.M.S. Installation Guide - 1 to 19
Att R.M.D.T. Installation Guide - 1 to 20
Att R.M.D.T. Installation Guide - 1 to 20
Att R.M.D.T. Installation Manual - GFT Shared Raii - Pages 1 to 40
Att S. Installation Manual, GFT Shared Raii - Pages 1 to 40
Att S. Installation Manual, GFT Shared Raii - Pages 1 to 40
Att S. Installation Manual, GFT Shared Raii - Pages 1 to 40
Att S. Installation Manual - GFT Shared Raii - Pages 1 to 40
Att S. Installation Manual - GFT Shared Raii - Pages 1 to 40
Att S. Installation Manual - GFT Shared Raii - Pages 1 to 40
Att S. Installation Manual - Pages 1 to 22
Att 10 NXT Horizon Installation Manual - Pages 1 to 22
Att 11 Schematics - NXT Horizon - Pages 1 to 13

PRODUCTS

CLASS - C531302 - POWER SUPPLIES - PHOTOVOLTAICS-PV Racking and clamping systems - CLASS - C531382 - POWER SUPPLIES - PHOTOVOLTAICS-PV Racking and clamping systems - Certified to US Standards

The reader is responsible for any liability arising from actions taken in interpretagor applying the results presented in this report. This report shall not be reportured except in full, nutbout without symbol from CSA Group Testing & Comficiation lies. The results of this report only relie to those items tested

34 Bursen, Irvine, CA, U.S.A. 92518 Telephone: 949.733.4300 1.800.463.6727 Fax: 949.733.4320 www.csagroup.org

© 2022 CSA Group. All rights reserved.

SHEET NUMBER PV-13

11" X 17"

SPEC SHEETS

SHEET NAME

SHEET SIZE ANSI B

DQD 507 10 Rev 2022-05-06

MARIA GONZALEZ 612 N 4TH ST, KINGSVILLE, TX 78363 USA UTILITY: AEP

INITIAL RELEASE 09/01/2022 DESCRIPTION VERSION

AHJ: CITY OF KINGSVILLE



Certificate of Compliance

Issued To: 80128750 Unirac

Project:

Certificate: 70131735

Master Contract: 266909

Date Issued:

2022-06-08

1411 Broadway NE Albuquerque, New Mexico, 87102 United States

Attention: Rob D'Anastasio

The products listed below are eligible to bear the CSA Mark shown with indicator 'US' for US only or without either indicator for Canada only. adjacent indicators 'C' and 'US' for Canada and US or with adjacent

Issued by: Michael Hoffragle
Michael Hoffragle



PRODUCTS

CLASS - C531302 - POWER SUPPLIES - PHOTOVOLTAICS-PV Racking and clamping systems - CLASS - C531382 - POWER SUPPLIES - PHOTOVOLTAICS-PV Racking and clamping systems -

Certified to US Standards



Certificate: 70131735 Project: 80128750

Master Contract: 266909 Date Issued: 2022-06-08

ULA .	Models: SM
Unirac Large Array is a ground mount system using the SolarMount (SM) platform for the bonding and grounding of PV modules.	SOLARMOUNT Flush-to-Roof is an extruded aluminum rail PV racking system that is installed parallel to the roof in landscape or portrait orientations.

DEL MAR, CA 92014, USA

powur

Solarmount

The system listed is designed to provide bonding/grounding, and mechanical stability for photovoltaic modules. The system is secured to the roof with the L-Foot components through the roofing material to building structure. Modules are secured to the racking system with the stainless steel or aluminum mid clamps and Aluminum end clamps. The modules are bonded to the racking system with the stainless-steel bonding mid clamps with piercing points. The system is grounded with 10 AWG copper wire to bonding/grounding lugs. Fire ratings of Class A with Type 1, 2, 3 (with metallic frame), 14 (with trim), 5 (with trim), 10 (with metallic frame), 19, 22, 25, 29, or 30 for steep slope. Tested at 5" interstitial gap which allows installation at any stand-off height.

The grounding of the system is intended to comply with the latest edition of the National Electrical Code, to include NEC 250 & 690. Local codes compliance is required, in addition to national codes. All grounding/bonding connections are to be torqued in accordance with the Installation Manual and the settings used luring the certification testing for the current edition of the project report.

The system may employ optimizers/micro-inverters and used for grounding when installed per installation

UL 2703 Mechanical Load ratings:

Downward Design Load (lb/ft²)	113.5
Upward Design Load (lb/ft²)	50.7
Down-Slope Load (lb/fl²)	16 13

Test Loads:

Downward Load (lb/ft³)	170.20
Upward Load (lb/ft²)	76.07
Down-Slope Load (lb/ft²)	24.2

INITIAL RELEASE 09/01/2022 DESCRIPTION VERSION

612 N 4TH ST, KINGSVILLE, TX 78363 USA UTILITY: AEP AHJ: CITY OF KINGSVILLE

MARIA GONZALEZ

SHEET NUMBER 11" X 17" **PV-14** SPEC SHEETS ANSI B SHEET NAME HEET SIZE



Engineering Alliance, Inc

https://www.eng-alliance.com

27-June-2022

Tel: 505 242 6411 Albuquerque, NM 87101 1411 Broadway Blvd. NE

Attn.: Engineering Department

Subject: Engineering Certification for the Unirac SOLARMOUNT Flush Rail System to Support Photovoltaic Panels,

modules to a roof structure and installed parallel to the roof. The Unirac SOLARMOUNT Flush-to-Roof is an extruded aluminum rail system that is engineered to hold most framed solar

We have reviewed the SOLARMOUNT system, a proprietary mounting system constructed from modular parts which are intended for rooftop installation of solar photovoltaic (PV) panels; and have reviewed the U-Builder 2.0 Online tool. This U-Builder 2.0 software includes analysis for the SOLARMOUNT rails (SM LIGHT rail, SM STANDARD rail, and SM HEAVY DUTY rail) with Standard and Pro Series hardware. All information, data and analysis are in compliance with the following codes, city

ASCE/SEI 7-05, 7-10, 7-16 Minimum Design Loads for Buildings and Other Structures International Building Code, 2006-2021 Edition w/ Provisions from SEAOC PV-2 2017 International Residential Code, 2006-2021 Edition w/ Provisions from SEAOC PV-2 2017

AC428, Acceptance Criteria for Modular Framing Systems Used to Support Photovoltaic (PV) Panels,

November 1, 2012 by ICC-ES

Aluminum Design Manual, 2015 & 2020 Edition

Following are typical specifications to meet the above code requirements:

Design Criteria:

Roof Mean Height = 0 - 60 (ft) Roof Pitch = 0 - 45 (degrees) Basic Wind Speed = 85 - 190 (mph)

Ground Snow Load = 0 - 100 (psf)

Exposure Category = B, C & D

For Houston, TX:

Basic Wind Speed ASD Minimum 110 mph to 147 mph (3-sec gust ASCE 7-05 for IRC)
Basic Wind Speed LRFD Minimum 142 mph to 190 mph (Vult ASCE 7-10 for IBC)

Per U-Builder 2.0 Engineering report.

Attachment Spacing:

The maximum cantilever length is L/3, where "L" is the span noted in the U-Builder 2.0 online

2" to 10" clear from top of roof to top of PV panel 1.0" tolerance for any specified dimension in this report is allowed for installation

Clearance:

Cantilever:

Installation Orientation: See SOLARMOUNT Rail Flush Installation Guide.

4603 April Meadow Way, Sugar Land, TX 77479. Ph: 832 865 4757



Engineering Alliance, Inc

mounted on the long side.

Portrait - PV Panel short dimension is parallel to ridge/eave line of the roof and the PV panel is andscape - PV Panel long dimension is parallel to ridge/eave line of the roof and the PV panel is.

mounted on the short side.

Components and Cladding Roof Zones:

Cladding design. The Components and Cladding Roof Zones shall be determined based on ASCE 7-05, ASCE 7-10 & 7-16 Component and

DEL MAR, CA 92014, USA

powur

Notes:

- U-Builder 2.0 Online tool analysis is only for Unirac SM SOLARMOUNT Rail Flush systems
- only and do not include roof capacity check. Risk Category II per ASCE 7-16.
- Topographic factor, kzt is 1.0.
- Array Edge Factor YE = 1.5
- Average parapet height is 0.0 ft.
- Wind speeds are LRFD values.
- Attachment spacing(s) apply to a seismic design category E or less.

Design Responsibility: The U-Builder 2.0 design software is intended to be used under the responsible charge of a registered design professional where required by the authority having jurisdiction. In all cases, this U-Builder 2.0 software should be used under the direction of a required by the authority having jurisdiction. In all cases, this U-Builder 2.0 software should be used under the direction of a design professional with sufficient structural engineering knowledge and experience to be able to:

- Evaluate whether the U-Builder 2.0 Software is applicable to the project, and
- Understand and determine the appropriate values for all input parameters of the U-Builder 2.0 software.

report and the manufacture specifications are in compliance with the above codes and loading criteria. This letter certifies that the Unirac SM SOLARMOUNT Rails Flush, when installed according to the U-Builder 2.0 engineering

This certification excludes evaluation of the following components:

- The structure to support the loads imposed on the building by the array, including, but not limited to: strength and deflection of structural framing members, fastening and/or strength of roofing materials, and/or the effects of snow accumulation on the structure
- The capacity of the solar module frame to resist the loads. 2) The attachment of the SM SOLARMOUNT Rails to the existing structure.
- This requires additional knowledge of the building and is outside the scope of the certification of this racking system

Please feel free to call for any questions or clarifications

Sugar Land, TX Engineering Alliance, Inc.



4603 April Meadow Way, Sugar Land, TX 77479. Ph: 832 865 4757

INITIAL RELEASE DESCRIPTION VERSION 09/01/2022 DATE UR. REV

MARIA GONZALEZ 612 N 4TH ST, KINGSVILLE, TX 78363 USA UTILITY: AEP AHJ: CITY OF KINGSVILLE

SHEET NAME

SPEC SHEETS

11" X 17" ANSI B

SHEET SIZE

SHEET NUMBER

PC350(WPI-1) | 0908



Application for Certificate of Compliance Form WPI-1

App ID:2300623

Physical Address of Structure to be Inspected

612 N 4TH ST

Tract/Addition:

City: Kingsville

ZIP: 78363

County: Kleberg

City Limits: Inside City Limits

Structure is located in:

Is the structure located in a Coastal Barrier Resource Zone (CBRA): No

Owner

Name:

Phone:

Mailing Address:

Contractor

City:

Name: 5-STAR SOLAR

Mailing Address: PO BOX 1531

Phone:

City: THREE RIVERS

Fax: ZIP: 78071

Engineer

Name: Nicholas M Carrillo Mailing Address: 1221 Avenue F Email: mitchell.carrillo@lynn-associates.com

Phone: (979) 245-8900 City: Bay City Texas Registration No.: 125070

Fax: ZIP: 774143413

Type of Building

Commencement of Construction Date

09-12-2022

Date of Application

House

09-12-2022

Inspections

1. Mechanical, Solar Panel(s) -

Number of Panels: 19, Location or Identifier: 3 FRONT, 6 RIGHT, 3 REAR, 7 LEFT,

2.

3.

Comments

Submitter

Name: Jasmine Cortez

Phone: (979) 245-8900

Date: 09-12-2022

Submitter Type: Engineer Staff

For Texas Department of Insurance Inspections: mail or email to your local field office

For inspections by engineers: mail or email to Austin office: windstorm@tdi.texas.gov

Texas Department of Insurance

Windstorm Inspections Program

P.O. Box 12030

Austin, TX 78711-2030

Texas Department of Insurance | www.tdi.texas.gov

1/2

PC350(WPI-1) | 0908



09-06-2022

Powur PBC

2683 Via De La Valle #321G

Attn.: To Whom It May Concern

re job: Maria Gonzalez

612 N 4th St, Kingsville, TX 78363, USA

The following calculations are for the structural engineering design of the photovoltaic panels and are valid only for the structural info referenced in the stamped plan set. The verification of such info is the responsibility of others.

I certify that the roof structure has sufficient structural capacity for the applied PV loads.

All mounting equipment shall be designed and installed per manufacturer's approved installation specifications.

Design Criteria:

Code: IBC 2018, IRC 2018, ASCE 7-10,

Live Load: 20 psf

Ult Wind Speed: 136 mph

Exposure Cat: C Ground Snow: 0 psf Min Snow Roof: 0 psf

Current Renewables Engineering Inc. Professional Engineer info@currentrenewableseng.com





09-06-2022

Powur PBC

2683 Via De La Valle #321G

Subject: Structural Certification for Installation of Residential Solar

re job: Maria Gonzalez

612 N 4th St, Kingsville, TX 78363, USA

Attn.: To Whom It May Concern

Observation of the condition of the existing framing system was performed by an audit team of Powur PBC

After review of the field observation data, structural capacity calculations were performed in accordance with applicable building codes to determine adequacy of the existing roof framing supporting the proposed panel layout. Please see full Structural Calculations report for details regarding calculations performed and limits of scope of work and liability. The design criteria and structural adequacy are summarized below:


Design Criteria:


Code: IBC 2018, IRC 2018, ASCE 7-10, Ult Wind Speed: 136 mph, Ground Snow: 0 psf, Min Snow Roof: 0 psf

ROOF 1: Shingle roofing supported by 2x4 Rafter @ 24 in. OC spacing. The roof is sloped at approximately 23 degrees and has a max beam span of 10.0 ft between supports. Roof is adequate to support the imposed loads. Therefore, no structural upgrades are required.

Current Renewables Engineering Inc. Professional Engineer info@currentrenewableseng.com



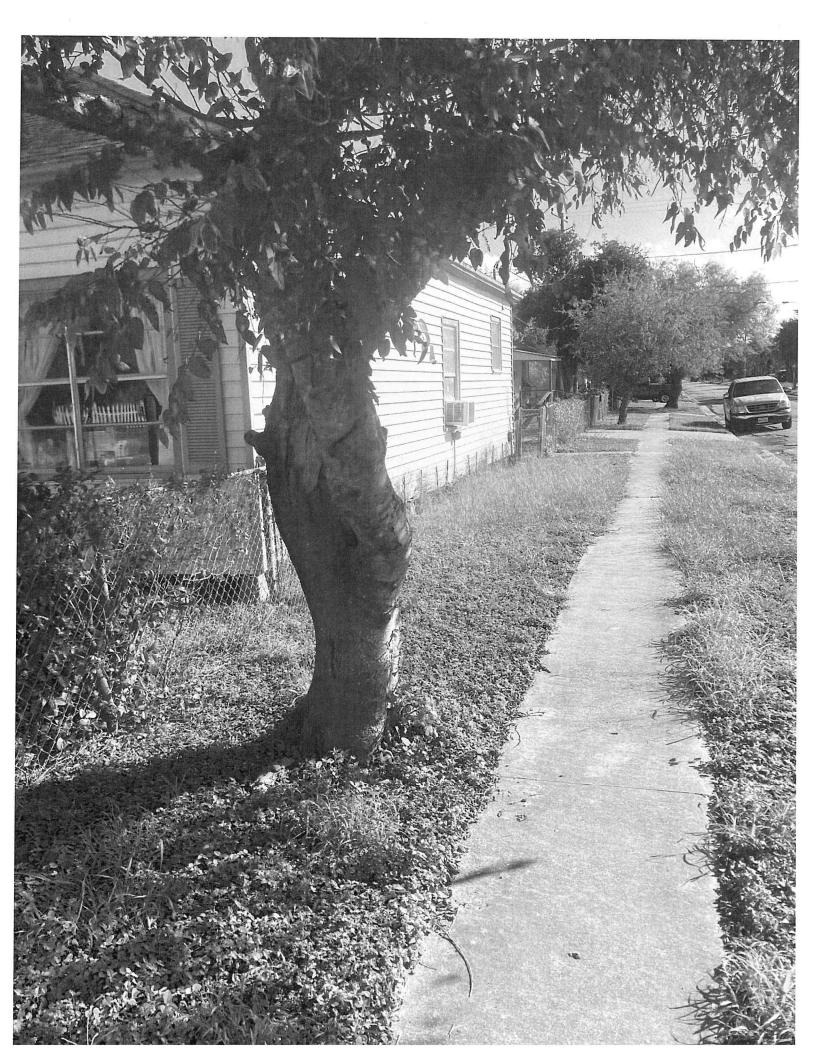

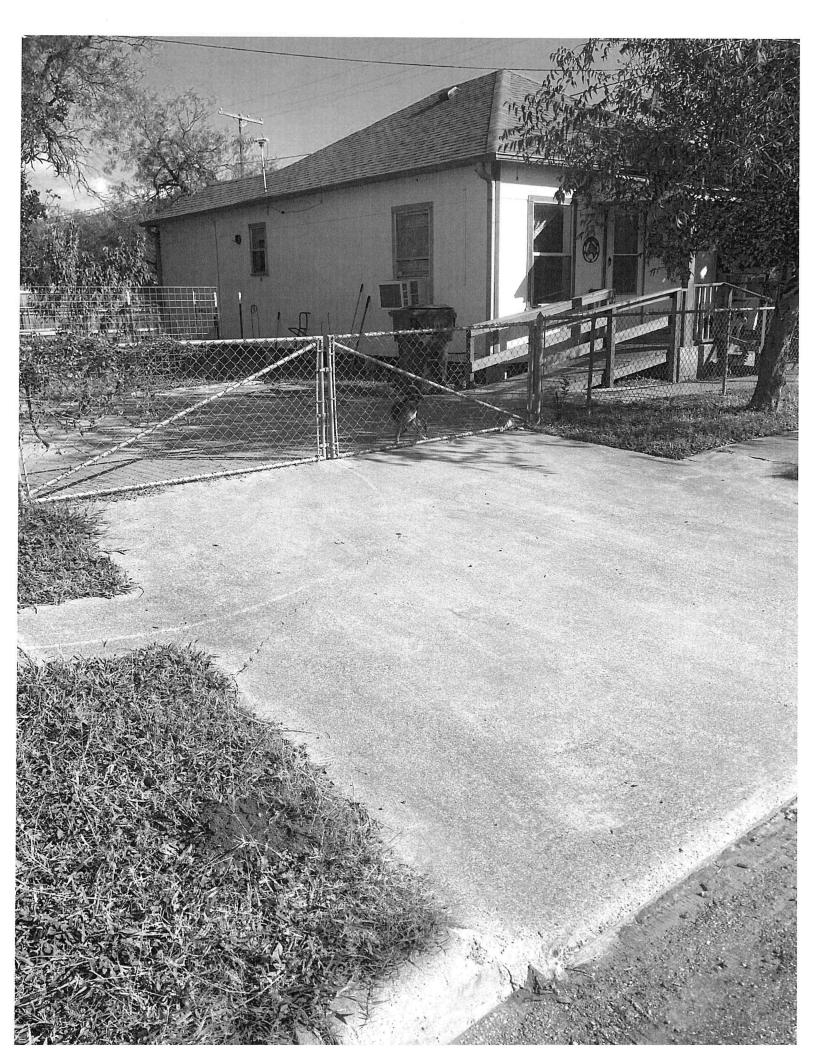



ITEM #2

CITY of KINGSVILLE DOWNTOWN



HISTORIC DEVELOPMENT BOARD

DATE:

November 4, 2021

TO:

Historic Development Board

FROM:

Kobby Agyekum (Senior Planner/Historical Preservation Officer)

SUBJECT:

Discuss and Consider Action to remove and replace siding, west side building from

fence to porch, south side building entirety on residential parcel on ORIG TOWN. Block 67. Lots 1-12 also known as 223 South 6th Street, Kingsville, TX 78363

APPLICANT:

Randy Rivers, Mr.

CONTRACTOR: Rivers Construction

REQUEST

Discuss and Consider Action to remove and replace siding, west side building from fence to porch, south side building entirety on residential parcel on ORIG TOWN, Block 67, Lots 1-12 also known as 223 South 6th Street, Kingsville, TX 78363

EXHIBITS

Application, 2022 Appraisal Roll, Kleberg County Appraisal District Information details, Data from Texas Historical Commission (Historic Resources Survey Form), Engineer's letter, Authorization letter. Drawings, and illustrations.

BACKGROUND & PERTINENT DATA

This is a 1935 Long rectangular-plan warehouse with gabled roof behind stepped parapet, board-andbatten wood siding, and a flat-roofed rectangular-plan side addition property, located within the Historic District. This property is associated with events that have made a significant contribution to the pattern of history.considered contributing to the historic district with low priority for preservation.

STAFF REVIEW & RECOMMENDATION

Staff has reviewed the application and found same to be in conformity with Standards of the Secretary of the Interior and the emerging Comprehensive Plan. Consequently, it is the recommendation of Staff to approve the installation of the driveway on the lot on residential building at 308 West Lee Avenue as there would be no adverse impact to the historic, cultural, or architectural nature of the district.

BOARD REVIEW

Scope of Historical Development Board

In general, Historical Development Board considers the following factors when making a recommendation concerning the issuing of a permit for the construction, reconstruction, alteration, restoration, relocation, demolition or razing of all or part of any building, structure or appurtenance within a historic district:

1) The effect of the proposed change upon the general historic, cultural and architectural nature of the district.

- 2) The appropriateness of exterior architectural features which can be seen from a public street, alley, road, highway or walkway.
- 3) The general design, arrangement, texture, material and color of the building, structure or appurtenances and the relation of such factors to similar features of buildings, structures or appurtenances in the district. The criterion shall not be the aesthetic appeal to the Board of the structure or the proposed remodeling, but rather its' conformity to the general character of the particular historic area involved.
- 4) Signs which are out of keeping with the character of the historic district in question shall not be permitted.
- 5) The value of the historic district as an area of unique interest and character shall not be impaired.

Standards of the Secretary of the Interior

- 1. A property shall be used for its historic purpose or be placed in a new use that requires minimal change to the defining characteristics of the building and its site and environment.
- 2. The historic character of a property shall be retained and preserved. The removal of historic materials or alteration of features and spaces that characterize a property shall be avoided.
- 3. Each property shall be recognized as a physical record of its time, place, and use. Changes that create a false sense of historical development, such as adding conjectural features or architectural elements from other buildings, shall not be undertaken.
- 4. Most properties change over time; those changes that have acquired historic significance in their own right shall be retained and preserved.
- 5. Distinctive features, finishes, and construction techniques or examples of craftsmanship that characterize a property shall be preserved.
- 6. Deteriorated historic features shall be repaired rather than replaced. Where the severity of deterioration requires replacement of a distinctive feature, the new feature shall match the old in design, color, texture, and other visual qualities and, where possible, materials. Replacement of missing features shall be substantiated by documentary, physical, or pictorial evidence.
- 7. Chemical or physical treatments, such as sandblasting, that cause damage to historic materials shall not be used. The surface cleaning of structures, if appropriate, shall be undertaken using the gentlest means possible.
- 8. Significant archeological resources affected by a project shall be protected and preserved. If such resources must be disturbed, mitigation measures shall be undertaken.
- 9. New additions, exterior alterations, or related new construction shall not destroy historic materials that characterize the property. The new work shall be differentiated from the old and shall be compatible with the massing, size, scale, and architectural features to protect the historic integrity of the property and its environment.
- 10. New additions and adjacent or related new construction shall be undertaken in such a manner that if removed in the future, the essential form and integrity of the historic property and its environment would be unimpaired.

SIGNATURES

Kobby Agyekum Senior Planner/HPO

Historical Development Board Review Application

TEXAS HIST	ORICAL COMMISSION	5
Project #: 00009 Historic Re	esources Survey Form	ocal Id: 0001-22822 City: Kingsville
Address No: 223 Street Name: Sou	uth 6th Street	City: Kingsville
SECTION 1		
Basic Inventory Information		
Current Name: Zarsky Lumber Company Historic Name: Kingsville Lumber Company		
Owner Information Name: Zarsky Lumber Co.	Status:	
Address: PO Box 2527 City: Victoria	State: TX	Zip: 77902
Geographic Location Latitude: 27.514452	Longitude: -97.867807	
Legal Description (Lot\Block): ORIG TOWN, BLOCK 6	57, LOT 1-12	
Addition/Subdivision:		Year:
Property Type Building		
Current Designations: NR District Is property	y contributing?	
□ NHL □ NR □ RTHL □ OTHM □ HTC	☐ SAL ☐ Local ☐ Other	
Architect:	Builder	
Contruction Date: 1935, 1970	Source Tax Appraiser	
Function		
Current: COMMERCE-Business		
Historic: COMMERCE-Business		

Recorded By: Florence Ruiz

Date Recorded:

5/9/2013



		TE	XAS HIST	ORICAL COM	MISSION	7		5
Project #: County:		Н	listoric Re	esources Surve	ey Form		0001-22822 Kingsville	
Address No:	223	Str	eet Name: Sou	ith 6th Street				
SECTION 3	Historica	al Informatio	n					
Associated H Commerce	listorical Con	text						
Applicable I	National Reg	ister (NR) Cri	iteria:					
✓ A	Associated	with events tha	nt have made a s	ignificant contribution t	to the broad p	attern of our hist	ory	
□в	Associated	with the lives o	f persons signific	ant in our past				
□ c	master, or			a type, period or metho represents a significan				5
□ D	Has yielded	, or is likely to	yield, information	n important in prehistor	ry of history			
Areas of Sig Commerce	nificance:							
Periods of S 1913-1946	ignificance:							
Levels of Sig	nificance:	□ National	☐ State	✓ Local				
Integrity:	✓ Location	Design	✓ Materials	✓ Workmanship	Setting	✓ Feeling	Association	1
Integrity No	tes:							
Individually	Eligible? No		Within Potent	ial NR District?: Yes		Is Property C	Contributing?:	\
Priority:	Medium	Expl	ain:					
Other Inforr Is prior docu		ıvailable for t	his resource?	Yes	Туре	☐ HABS ☑ Su	urvey \square Othe	:r
Documentat 1982 Kingsvill								

· t

5 TEXAS HISTORICAL COMMISSION Historic Resources Survey Form Project #: 00009 Local Id: 0001-22822 County: Kleberg City: Kingsville Address No: 223 Street Name: South 6th Street **SECTION 2 Architectural Description** Long rectangular-plan warehouse with gabled roof behind stepped parapet, board-and-batten wood siding, and a flat-roofed rectangular-plan side addition. ☐ Additions, modifications Explain: ☐ Relocated Explain: Stylistic Influence No Style **Structural Details Roof Form** Gabled with parapet **Roof Materials** metal **Wall Materials** WOOD-Siding Windows **Doors (Primary Entrance** Plan Rectangular Chimneys Porches/Canopies **FORM** SUPPORT **MATERIAL** ANCILLARY BUILDINGS: Garage: Barn: Shed: Other: Landscape Features

Kleberg CAD

Property Search > 22822 ZARSKY LUMBER CO Tax Year: 2022 - Values not available for Year 2022

Property

Type:

А	r	r	n	ш	r	1	т
_	·	·	v	ч		ı	·

Property ID:

22822

Legal Description: ORIG TOWN, BLOCK 67, LOT 1-12

Geographic ID:

Real

100106701000192

Zoning:

Agent Code:

C2

Property Use Code:

Property Use Description:

Location

Address:

223 S 6TH ST

Mapsco:

Neighborhood:

Neighborhood CD:

Map ID:

C1

Owner

Name:

ZARSKY LUMBER CO

Owner ID:

30451

Mailing Address:

(=) Assessed Value:

PO BOX 2527

% Ownership:

100.0000000000%

VICTORIA, TX 77902-2527

Exemptions:

N/A

Values

(+) Improvement Homesite Value:	+	N/A	
(+) Improvement Non-Homesite Value:	+	N/A	
(+) Land Homesite Value:	+	N/A	
(+) Land Non-Homesite Value:	+	N/A	Ag / Timber Use Value
(+) Agricultural Market Valuation:	+	N/A	N/A
(+) Timber Market Valuation:	+	N/A	N/A
(=) Market Value:	=	N/A	
(–) Ag or Timber Use Value Reduction:	_	N/A	
(=) Appraised Value:	=	N/A	
(–) HS Cap:	_	N/A	

2 argky Lumber Co. Remodle

West side building in packing Lot removed replace Approx 36' x 10' tal. siding d under layment. Faint to make Existing Siding picture II Z New siding to match picture III was chouse Across street from main store,

South Side building

Remove a replace all siding d

trime Picture # 3

Match existing style but

different materials.

Materials

West 31dp to be 1/2 underly mont,


house wrap of 1×12 hardi 51ding.


House trum to be 1×4 of 1×6 hardi board,

South 51de by be 4×8 sheets hardi

1×4 hardi board for battens.


trum 1×4 d 1×6 hardi.

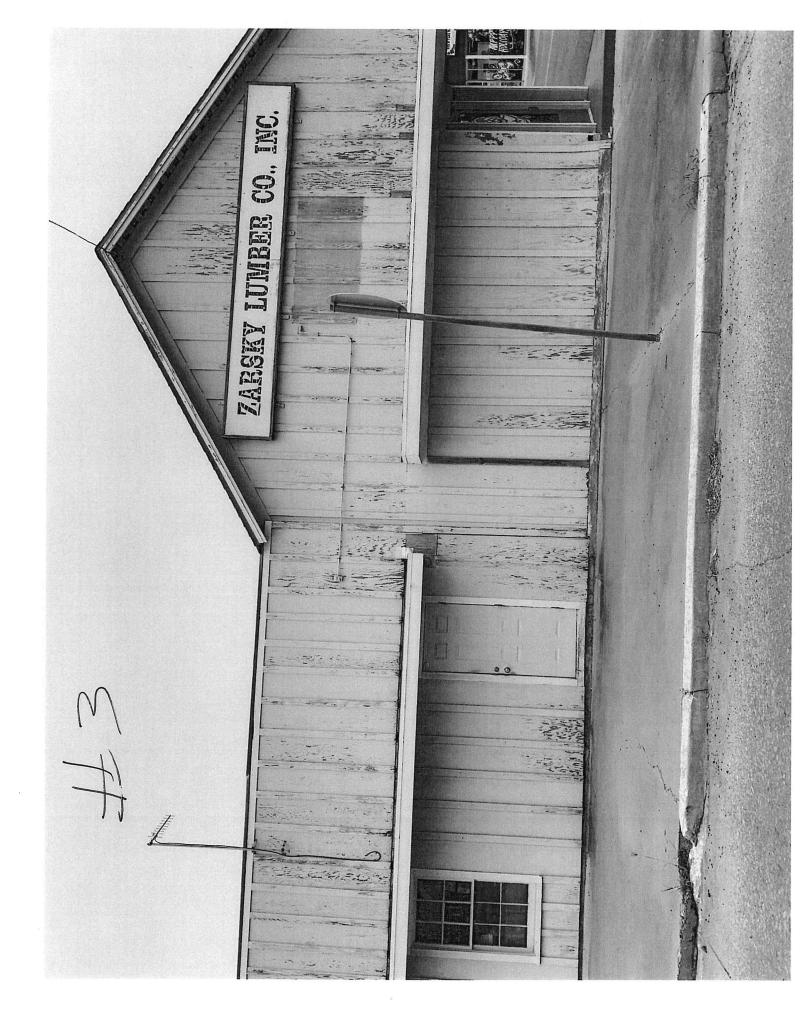

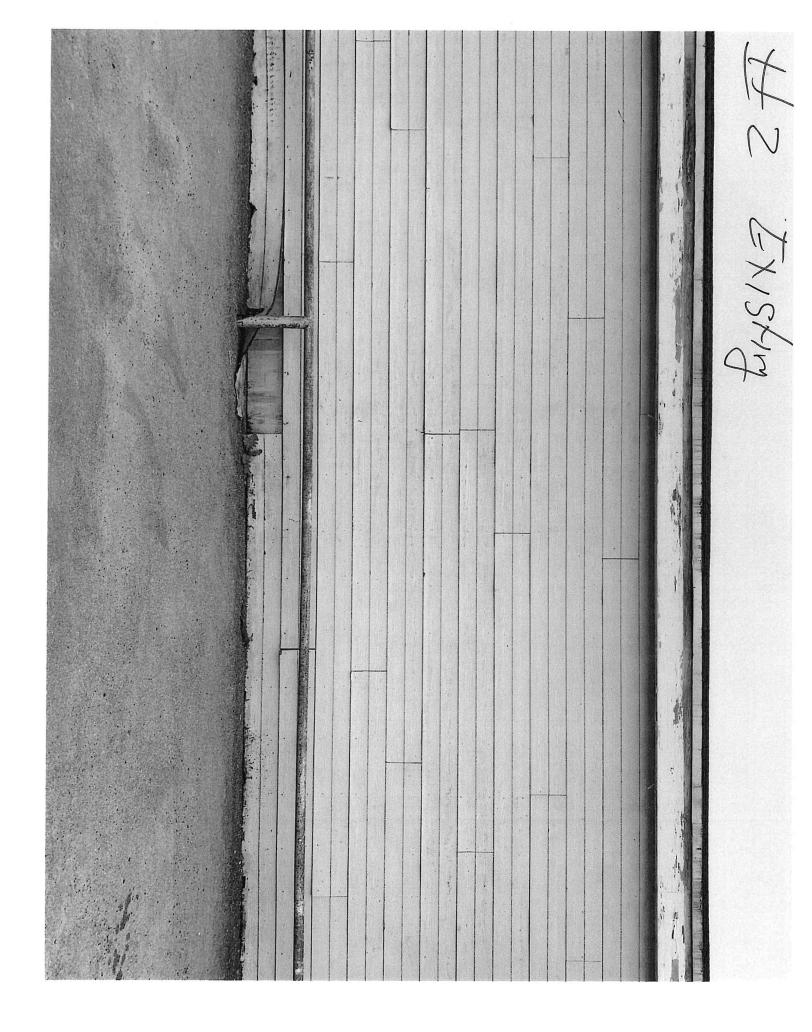




3 (4) (c) ⊙ ⊙ ⊝ PROJECT REMOVE AND REPLACE EXISTING SIDING.
SHEATHING, HOUSE WRAP, AND ROTTEN WALL
FRANING, PROPOSED AS HARDIE PAREL SIDING
CEDAR MILL, WITH 14 VERTICAL HARDIE BATTENS, Z
FLASHING AT HORIZONTAL JOISTE, L. NETAL
FLASHING ABOVE AWNINGS, 1.2" OSB SHEATHING,
AND VAPOR BARRIER OVER IT. PROPOSED HARDIE
PANEL TRIM WHERE NEEDED. REMOVE EXISTING SIDING AND UNDERLAYMENT AND VAPOR BARRIER, REMOVE EXISTING SHEATHING, REMOVE AND REPLACE EXISTING RAFTUR FRAMING 2X'S. PROPOSED L2" OSB SHEATHING, VAPOR BARRIER, AND 1." HORIZONTAL HARDIE PANEL SIDING, PROPOSED PAINT "L" METAL FLASHING, 6X6-28 GAUGE PROPOSED POWER WASH, CAULK AND PAINT EXISTING EXPOSED RAFTERS TO BE STAINED EXISTING POSTS TO BE REBOXED AND STAINED W LOTT AVE LOCATION S 5TH ST TOTT AVE KTEBEBG VAC 3.4 Z.T.S S HIOT TZ HTOT N ם AZ

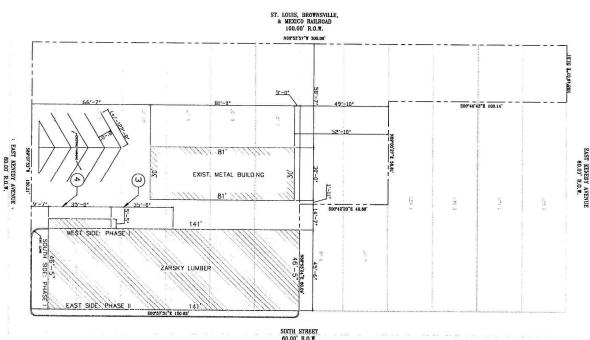

	CARSKY	CLIENT	SITE P	DATE: SEPT.	Par	were woo
COPY RIGHT 207:	A1.0	SHEET NO	ž	26, 2022	in is	CARO


1:16

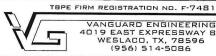

VANGUARD ENGINEERING 4D19 EAST EXPRESSWAY B3 WESLACO, TX, 78596 (956) 514-5086

THIS IS THE PROPERTY OF THE PROFESSIONAL ENGINEER WHOSE SEAL APPEARS ON THIS DRAWING AND IT IS UNLAWFUL TO REUSE THIS DRAWING ON ANY OTHER PROJECT, OR TO COPY, TRACE OR IN ANY OTHER WAY, DEPRODUCE ANY OR ALL PARIS OF THIS DRAWING WITHOUT THE WRITTEN CONSENT OF THE ENGINEER.

PHASE I & II 226 S. 6TH ST. KINGSVILLE,TX

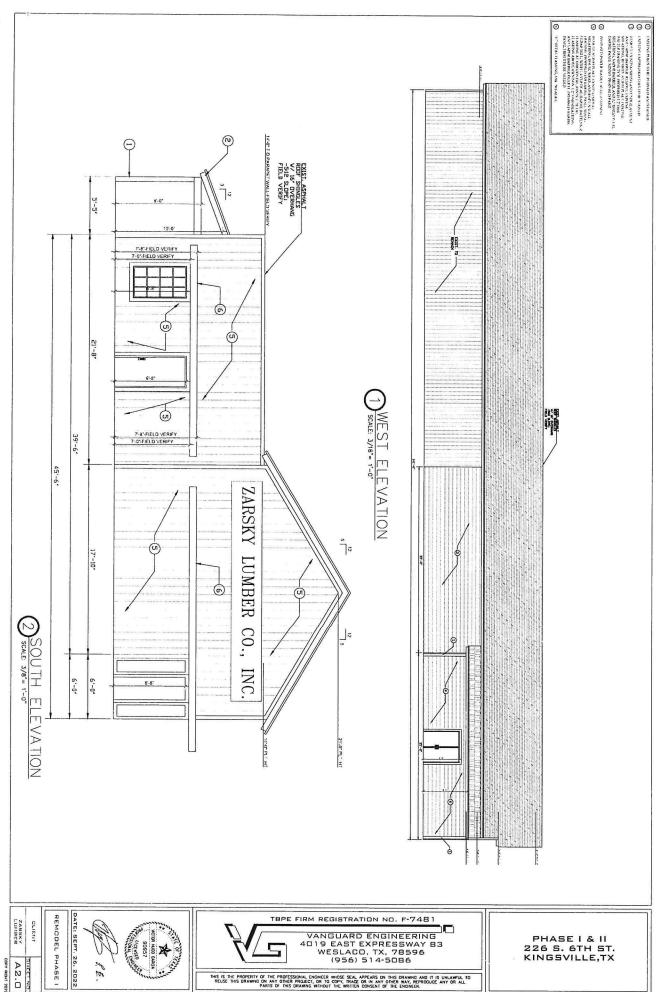

THIS IS THE PROPERTY OF THE PROFESSIONAL ENGINEER WHOSE SEAL APPEARS ON THIS ORAWING AND IT IS UNLAWFUL TO REUSE THIS DRAWING ON ANY OTHER PROJECT, OR TO COPY, TRACE OR IN ANY OTHER WAY, REPRODUCE ANY OR ALL PARTS OF THIS DRAWING WHITOUT THE WITHER CONSIST OF THE ENDINEER.

SCALE: 3/16"= 1"-0"

Ā - III	100 100 100 100 100 100 100 100 100 100	
7. %	1/	

	LUMBER	CLIENT	REMODEL	DATE: SEPT.	A A	Social moc
COPY RIGHT 2022	A3.0	SHEET NO	PHASE 2	26, 2022	100	A STATE OF THE STA

TBPE FIRM REGISTRATION NO. F-7481

VANGUARD ENGINEERING 4019 EAST EXPRESSWAY 83 WESLACO, TX, 78596 (956) 514-5086

THIS IS THE PROPERTY OF THE PROFESSIONAL ENGNEER WHOSE SEAL APPEARS ON THIS DRAWING AND IT IS UNLAWFUL TO REUSE THIS DRAWING ON MY OTHER WAY, REPRODUCE ANY OR ALL PARTS OF THIS DRAWING WHOLE IT WITH DRAWING THE CONSENT OF THE CHARLES.

PHASE I & II 226 S. 6TH ST. KINGSVILLE,TX



CITY OF KINGSVILLE

Planning Department
Building Permit Application
Phone No: (361) 595-8019
Submit the completed form and the Building Official will

7	review your application	on and property before starting the following job.
DATE:	PERMIT#:	APPROVED BY:
70		
JOB ADDRESS: 223	South 1	le the
OWNER'S NAME: LAST:	1	FIRST: M:
2.00	sky lund	Dec Co
MAILING ADDRESS:		PHONE NO:
		592-434/
CITY:	STATE:	ZIP CODE: 5 C/O
CONTRACTOR: *	p Ver	× / / / / / / / / / / / / / / / / / / /
151085	censt	PHONE NO: 956-239-3051
DESCRIPTION OF WORK:	☐ New	E Remodel
KADIACA SI	lim' squ	are Feet
Remove & R	solor of CI	1: /2/ 1. 11/2
	eplace SI	ding/taction wastwall asouth i
VACUATION OF WORK: \$		PERMIT/FEE: \$
* Contractor must be re	gistered with the City	v of Kingsville
ľ	NO	TICE
SEPARATE PERMITS ARE R	EOUIRED FOR, FLECTI	RICAL PLUMBING HEATING VENETILATING
THE COMBILIONING. ALL	CONTRACTORS ARE R	RESPONSIRIE FOR DISPOSING OF THEIR OWN-
DEDICIO AT THE DAMITAKE	LANDFILL ON CR 213	O THIS PERMIT RECOMES MILLI AND VOYS
HOYER ON COMPT KOCITO	N AUTHORIZED IS NOT	COMMENCED WITHIN SIY MONTHS OF IT
ANY TIME AFTER WORK IS	7 12 2025FUDED OK VE	BONDONED FOR A PERIOD OF 6 MONTHS AT
THE THE PER WORK IS	COMMENCED.	
I HEARBY CERTIFY THAT I HAVE	READ AND EXAMINED THIS	S APPLICATION AND KNOW THE SAME TO BE TRUE AND
		A PERMIT DOES NOT PRESUME TO GIVE AUTHORITY TO TE OR LOCAL LAW REGULATION CONSTRUCTION OR THE
PERFORMANCE OF CONSTRUCT	ON.	22 ON LOCAL DAY REGULATION CONSTRUCTION OR THE
Kn 16	17_	11 700 1
CICNATURE	10-	13 2021
SIGNATURE /	DATE	/
HOMEOWNER APPLICANTS ONI	Y: I HEREBY CERTIFY THAT	TI OWN AND AM NOW LIVING AT THE DWELLING FOR WHICH
THIS PERMIT IS BEING ISSUED,	AND THAT THE WORK IS B	EING PERMORMED BY ME OR A MEMBER OF MY IMMEDIATE
PARENT, CHILD OR CHILD'S SPO		IS APPLICATION, MY IMMEDIATE FAMILY IS LIMITED TO MY
	NITIAL HERE	
	FOR OFFIC	CE USE ONLY
BUILDING PERMIT ISSUED:		
BUILDING PERMIT EXPIRES		
BUILDING PERMIT ISSUED	BY:	

Show \underline{NORTH} arrow on (PLOT PLAN)

LOT SIZE:	•
1. Width of lot 2. Len	gth of lot
BUILDING SETBACKS 1. Front 2. Right Side	
3. Left Side 4. Back	
SHOWFOR EXISTING	SHOWFOR ALTERATION
Pro	operty Line
	South wall our d Replace on the existing style, the service of the style of the sty
ST	REET

ITEM #3

CITY of KINGSVILLE DOWNTOWN



HISTORIC DEVELOPMENT BOARD

DATE:

November 4, 2021

TO:

Historic Development Board

FROM:

Kobby Agyekum (Senior Planner/Historical Preservation Officer)

SUBJECT:

Discuss and Consider Action to construct a driveway on residential parcel on ORIG

TOWN, Block 19, Lots 20-26 also known as 308 West Lee Avenue, Kingsville, TX

78363

APPLICANT:

Argelio Alanis, Mr. CONTRACTOR: Argelio Alanis, Mr.

REQUEST

Discuss and Consider Action to construct a driveway on residential parcel on ORIG TOWN, Block 19, Lots 20-26 also known as 308 West Lee Avenue, Kingsville, TX 78363

EXHIBITS

Application, 2020 Appraisal Roll, Kleberg County Appraisal District Information details, Data from Texas Historical Commission (Historic Resources Survey Form), Engineer's letter, Authorization letter, Drawings, and illustrations.

BACKGROUND & PERTINENT DATA

This is a 1940 one-and-a-half-story rectangular-plan hip-roofed residential building with inset partialwidth entry Porch supported by square wood posts, sash windows, horizontal siding, shed-roofed dormers on each side and small one-car garage and ancillary building at rear of property, located within the Historic District. This property is considered contributing to the historic district with low priority for preservation.

STAFF REVIEW & RECOMMENDATION

Staff has reviewed the application and found same to be in conformity with Standards of the Secretary of the Interior and the emerging Comprehensive Plan. Consequently, it is the recommendation of Staff to approve the installation of the driveway on the lot on residential building at 308 West Lee Avenue as there would be no adverse impact to the historic, cultural, or architectural nature of the district.

BOARD REVIEW

Scope of Historical Development Board

In general, Historical Development Board considers the following factors when making a recommendation concerning the issuing of a permit for the construction, reconstruction, alteration, restoration, relocation, demolition or razing of all or part of any building, structure or appurtenance within a historic district:

1) The effect of the proposed change upon the general historic, cultural and architectural nature of the district

- 2) The appropriateness of exterior architectural features which can be seen from a public street, alley, road, highway or walkway.
- 3) The general design, arrangement, texture, material and color of the building, structure or appurtenances and the relation of such factors to similar features of buildings, structures or appurtenances in the district. The criterion shall not be the aesthetic appeal to the Board of the structure or the proposed remodeling, but rather its' conformity to the general character of the particular historic area involved.
- 4) Signs which are out of keeping with the character of the historic district in question shall not be permitted.
- 5) The value of the historic district as an area of unique interest and character shall not be impaired.

Standards of the Secretary of the Interior

- 1. A property shall be used for its historic purpose or be placed in a new use that requires minimal change to the defining characteristics of the building and its site and environment.
- 2. The historic character of a property shall be retained and preserved. The removal of historic materials or alteration of features and spaces that characterize a property shall be avoided.
- 3. Each property shall be recognized as a physical record of its time, place, and use. Changes that create a false sense of historical development, such as adding conjectural features or architectural elements from other buildings, shall not be undertaken.
- 4. Most properties change over time; those changes that have acquired historic significance in their own right shall be retained and preserved.
- 5. Distinctive features, finishes, and construction techniques or examples of craftsmanship that characterize a property shall be preserved.
- 6. Deteriorated historic features shall be repaired rather than replaced. Where the severity of deterioration requires replacement of a distinctive feature, the new feature shall match the old in design, color, texture, and other visual qualities and, where possible, materials. Replacement of missing features shall be substantiated by documentary, physical, or pictorial evidence.
- 7. Chemical or physical treatments, such as sandblasting, that cause damage to historic materials shall not be used. The surface cleaning of structures, if appropriate, shall be undertaken using the gentlest means possible.
- 8. Significant archeological resources affected by a project shall be protected and preserved. If such resources must be disturbed, mitigation measures shall be undertaken.
- 9. New additions, exterior alterations, or related new construction shall not destroy historic materials that characterize the property. The new work shall be differentiated from the old and shall be compatible with the massing, size, scale, and architectural features to protect the historic integrity of the property and its environment.
- 10. New additions and adjacent or related new construction shall be undertaken in such a manner that if removed in the future, the essential form and integrity of the historic property and its environment would be unimpaired.

SIGNATURES

Kobby Agyèkum Senior Planner/HPO

Historical Development Board Review Application

Applicant: Argelio Alanis
Address: 523 E Angle RD dinivile +x
Contact: Cell: 36/- 572 66 14 Home:
Email:
Property Owner: 1 James B. Luber
Address: 30/8 West hee
Contact: Cell: 361-537-556/Home:
Property Location and Description: 308 West Lee Drive Way & Handres Vanp
Description of Work: Driveway Contrete
North Mic
Contractor: Hrgelio Hlanis
Contact: Cell: Home:
Email:
Documents Required:
1. Sketch, Drawing, Plans, Site Plans, Mock-ups
 Photographs (Historic, Current, Surrounding Structures) Materials List or Samples
4. Proof of Ownership
5. Letter of Representation and Work Approval from Property Owner
(If Applicable)
I certify that this information and the additional information submitted to the Planning Department is correct and that the work will be completed as described, as approved by the Historical Development Board and in accordance with applicable codes.
(Applicant) Print Name: AVQ e/jo AlaniS
Signature: Mulis Glam Date: 10-3 22

	TEXAS HISTORIC	AL COMMISSION	381
Project #: 00009 County: Kleburg	Historic Resour	ces Survey Form	Local Id: City: Kingsville
Address No: 308	Street Name: West Lee Av	venue	
SECTION 1			
Basic Inventory Informa	tion		
Current Name: Historic Name:			
Owner Information Name:	Luker James B. Jr.	Status:	
Address: PO Box 1216	City: Kingsville	State: TX	Zip: 78364
Geographic Location	Latitude: 27.519869	Longitude: -97.8711	11
Legal Description (Lot\Block):	ORIG TOWN, BLOCK 19, LOT 2	20-22	
Addition/Subdivision:			Year:
Property Type Buil	ding		
Current Designations: \Box	NR District	uting?	
□ NHL □ NR □ RTHL	□ отнм □ нтс □ ѕл	AL 🗆 Local 🗆 Other	
Architect:	В	uilder	
Contruction Date: c. 1920	s	ource Sanborn maps	
Function			
Current: DOMESTIC-Single Dwe	lling		
Historic: DOMESTIC-Single Dwe	elling		

Recorded By:

Date Recorded:



TEXAS HISTORICAL COMMISSION

Project #: 00009 County: Kleburg Historic Resources Survey Form

Local Id:

City: Kingsville

381

Address No: 308


Street Name: West Lee Avenue

SE	CT	ION	12

Architectural Description

posts, sash windows, horizon property.	ital siding, shed-roofed dor	mers on each side, and small one-	th entry porch supported by square v car garage and ancillary building at r	ear of
☐ Additions, modifications	Explain:			
☐ Relocated	Explain:			
Stylistic Influence				
No Style				
Structural Details				
Roof Form				
hipped				
Roof Materials				
Composition Shingles				
Wall Materials				
Hardiplank siding, Wood Shi	ngles			
Windows				
Sash				
Doors (Primary Entranc	е			
Composition Shingles				
Plan				
Rectangular				
Chimneys				
Porches/Canopies				
FORM Other: inset				
SUPPORT Wood posts (pl	lain)			
MATERIAL				
ANCILLARY BUILDINGS:				
Garage: 1	Barn:	Shed: 1	Other:	
Landscape Features				
				araman (d)
•				

	4014		XI					1000
		TE	XAS HIST	ORICAL COM	MISSIO	7		381
Project #:	00009	H	listoric Re	esources Surve	ey Form	Local Id:		
County:	Kleburg					City:	Kingsville	
Address No:			eet Name: We	est Lee Avenue				
SECTION 3		al Informatio	n					
Associated H Planning/Dev		ntext						
Applicable	National Reg	gister (NR) Cr	iteria:				169	
✓ A	Associated	with events that	at have made a s	significant contribution (to the broad p	oattern of our his	tory	
□в				cant in our past				
□с	master, or	the distinctive of possesses high lual distinctions	haracteristics of artistic value, or	a type, period or methor represents a significan	od of construct t and distingu	tion or represent uishable entity wh	s the work of a nose components	S
□ D	Has yielded	d, or is likely to	yield, informatio	n important in prehisto	ry of history			
Areas of Sig								
Community D								
Periods of S 1913-1946	ignificance:							
Levels of Sig	nificance:	☐ National	☐ State	✓ Local				
Integrity:	Location	Design	✓ Materials	✓ Workmanship	Setting	✓ Feeling	Association	
Integrity No	tes:							
Individually	Eligible? No		Within Potent	ial NR District?: No		Is Property C	Contributing?:	V
Priority:	Medium	Expl	ain:					
Other Inforn	nation							
Is prior docu	ımentation a	vailable for t	nis resource?	No	Туре	☐ HABS ☐ Su	ırvey 🗌 Other	r
Documentat	ion Details:	-						

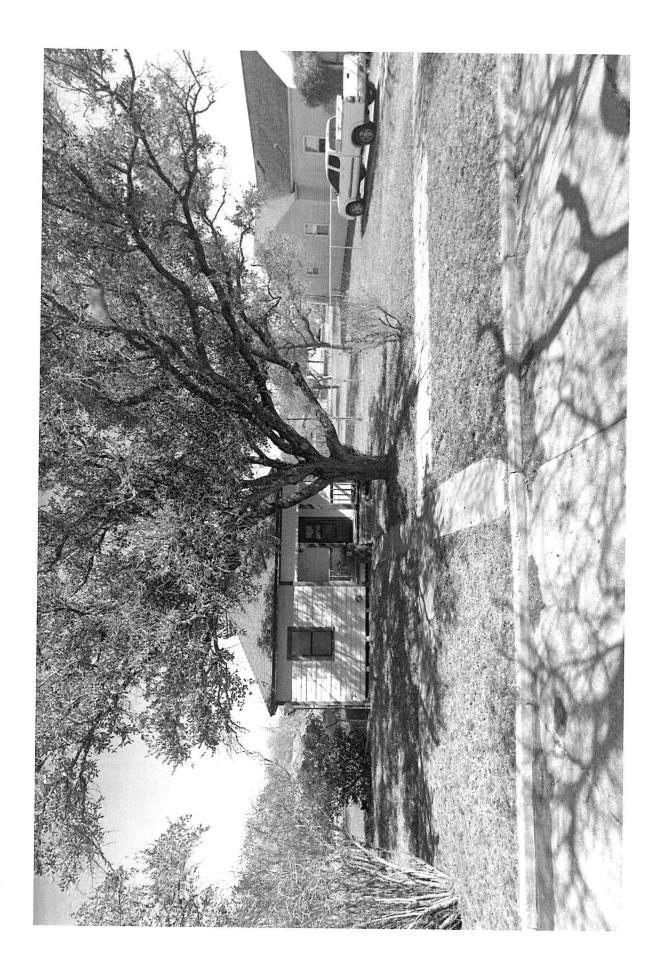

M 1/2nog 300 ,05 €. CS+ENT SON OF THE PERSON

-

City of Kingsville



Application for Fence/Driveway/Sidewalk/Parking Lot

City of Kingsville, 400 W. King Avenue, Kingsville, TX 78363, www.cityofkingsville.com
Planning and Development Department, Phone 361-595-8055, plansingsuille.com

Project Information (Please Print)
Project Address: 908 Wzgt Lee
Legal Description:
Fence:Chain LinkSplit RailPicketShadowboxWrought-IronStoneBrickBlock
Other Material Height: Cost of Fence (including erection) \$
Check work use and type:ResidentialCommercialDrivewaySidewalkParking Lot
Check work detail: New DrivewayAddition to existing drivewayRemove & replace driveway
New Approach ConcreteAsphaltPaversStone Base
Paving Thickness: DrivewayApproach Stone Base Thickness: DrivewayApproach
Name and Address of Property Owner (Please Print)
Property Owner Name: 2 January Phone Number: 361-537-5500
Street Address: 30 & West Lee
City:
Email Address:
Name and Address of Applicant or Contractor (If different from Owner: Please Print)
Company Name: At gelio Alavis
Contact Person: 36(-526-6611) Phone Number:
Contact Person: 361-522-6611 Phone Number: Street Address: 523 E Angle RD Kimiville +x
City: State: Sip Code:
Email Address:
The undersigned hereby makes an application to construct a fence/driveway/sidewalk/parking lot as specified herein and as shown on the drawings, and agrees to comply with the provisions of the Building and Zoning Codes, Engineering, Design Standards of the City of Kingsville, and previous info provided under permit instructions attached whether the same is specified herein or not. Applicant Signature: Date:
Property Owner's Signature: 2 Just 6 Date: 1 - 4-2022
Property Owner's Signature: X Date: